

Public Notice Details

Planning Application Details

Application No	DA2500130
----------------	-----------

Property Details

Property Location	14 Monteith Crescent Bagdad
Property Location	14 Montelli Crescent Buguda

Application Information

Application Type	Discretionary Development Application
Development Category	Dwelling
Advertising Commencement Date	8/10/25
Advertising Closing Period	22/10/25
If the Council Offices are closed during normal office hours within the above period, the period for making representations is extended.	

Enquiries regarding this Application can be made via to Southern Midlands Council on (03) 6254 5050 or by emailing planningenquires@southernmidlands.tas.gov.au. Please quote the development application number when making your enquiry.

Representations on this application may be made to the General Manager in writing either by

Post: PO Box 21, Oatlands Tas 7120 Email: mail@southernmidlands.tas.gov.au

Fax: 03 6254 5014

All representations must include the authors full name, contact number and postal address and be received by the advertising closing date.



APPLICATION FOR PLANNING PERMIT – USE AND DEVELOPMENT Residential Use

Use this form to apply for planning approval in accordance with section 57 and 58 of the Land Use Planning and Approvals Act 1993

	, , , , , ,			• ,,	
Applicant / Ov	vner Details:				
Owner / s Name	Wilsdon Homes Tasmania Pty Ltd				
	250 Murray Stre	et, Hobart,7000			
Postal Address			Phone No:		
			Fax No:		
Email address:			sonya	a.gadd@v	wilsonhomes.com.au
Applicant Name (if not owner)	Wilson Homes P	PTY LTD			
Postal Address:	250 Murray Stre	et	Phone No:	(03) 621	39920
	Hobart	TAS	Fax No:		
Email address:			sonya	a.gadd@v	wilsonhomes.com.au
Description of	proposed use and	l/or development:			
Address of new use and development:	14 Monteith Crescent, Bagdad				
Certificate of Title No:	Volume No 185527	Lot No:	46		
Description of	New Building			ie: New Demoli	v Dwelling /Additions/ tion / /Shed / Farm Building
proposed use or development:			Dwelling	/ Carpo	ort / Swimming Pool or other etc.
huildings			re there any existing ngs on this title?		
Current use of land and buildings:				If yes used	, what is the main building as?
F	Please tick ✓answer				
ls the property Heritage Listed	Yes	No			
Proposed Material	What are the proposed external wall materials	Brick/Cladding	What is the proposed material	d roof	Colourbond
	What are the proposed external wall colours	ТВС	What is the proposed	d roof colour	TBC
	What is the proposed new floor area m ² .	162.99	What is the estimate all the new work prop		375K

Please attach any additional information that may be required by Part 6.1 Application Requirements of the Tasmanian Planning Scheme.

Signed Declaration	

I/we hereby apply for a planning approval to carry out the use or development described in this application and in the accompanying plans and documents, accordingly I declare that:

- 1. The information given is a true and accurate representation of the proposed development. I understand that the information and materials provided with this development application may be made available to the public. I understand that the Council may make such copies of the information and materials as, in its opinion, are necessary to facilitate a thorough consideration of the Development Application. I have obtained the relevant permission of the copyright owner for the communication and reproduction of the plans accompanying the development application, for the purposes of assessment of that application. I indemnify the Southern Midlands Council for any claim or action taken against it in respect of breach of copyright in respect of any of the information or material provided.
- 2. I am the applicant for the planning permit and I have notified the owner/s of the land in writing of the intention to make this application in accordance with Section 52(1) of the Land Use Planning Approvals Act 1993 (or the land owner has signed this form in the box below in "Land Owner(s) signature);

Applicant Signature (If not the Owner)	Applicant Name (Please print) Fimothy Ribbons	Date 17/09/2025
Land Owner(s) Signature	Land Owners <i>Name (please print)</i> Wilson Homes	Date 17/09/2025
Land Owner(s) Signature	Land Owners Name (please print)	Date

RESIDENTIAL DEVELOPMENT – Information & Checklist sheet

Use this check list for submitting your application

Submitting your application ✓

1.	All plans and information required per Application Requirements of the Planning Scheme www.iplan.tas.gov.au				
	ie: site plan showing all existing buildings, proposed buildings, elevation plans etc.				
2.	Copy of the current Certificate of Title, Schedule of Easements and Title Plan (Available from Service Tasmania Offices)				
3.	Any reports, certificates or written statements to accompany the Application (if applicable) required by the relevant zone or code.				
4.	Prescribed fees payable to Council				
Inf	formation				
pro Tra	ou provide an email address in this form then the Southern Midlands Council ("the Council") will treat the ovision of the email address as consent to the Council, pursuant to Section 6 of the Electronic ansactions Act 2000, to using that email address for the purposes of assessing the Application under the nd Use Planning and Approvals Act 1993 ("the Act").				
	ou provide an email address, the Council will not provide hard copy documentation unless specifically quested.				
	s your responsibility to provide the Council with the correct email address and to check your email for nmunications from the Council.				
If y	ou do not wish for the Council to use your email address as the method of contact and for the giving of				
info	ormation, please tick ✓ the box				
He	ritage Tasmania				
He	If the Property is listed on the Tasmanian Heritage Register then the Application will be referred to Heritage Tasmania unless an Exemption Certificate has been provided with this Application. (Phone 1300 850 332 (local call cost) or email enquires@heritage.tas.gov.au)				
Та	sWater				
	pending on the works proposed Council may be required to refer the Application to TasWater for sessment (Phone 136992)				

PRIVACY STATEMENT

The Southern Midlands Council abides by the Personal Information Protection Act 2004 and views the protection of your privacy as an integral part of its commitment towards complete accountability and integrity in all its activities and programs.

Collection of Personal Information: The personal information being collected from you for the purposes of the Personal Information Protection Act, 2004 and will be used solely by Council in accordance with its Privacy Policy. Council is collecting this information from you in order to process your application.

Disclosure of Personal Information: Council will take all necessary measures to prevent unauthorised access to or disclosure of your personal information. External organisations to whom this personal information will be disclosed as required under the Building Act 2000. This information will not be disclosed to any other external agencies unless required or authorised by law.

Correction of Personal Information: If you wish to alter any personal information you have supplied to Council please telephone the Southern Midlands Council on (03) 62545050. Please contact the Council's Privacy Officer on (03) 6254 5000 if you have any other enguires concerning Council's privacy procedures.

ADVICE: There is no connection between Planning approval and Building & Plumbing approvals. Owners are to ensure that the work is either Low Risk Building Work, Notifiable Building Work or Permit work in accordance with the Directors Determination – Categories of Building & Demolition Work v 1.4 dated 12 March 2021.

https://www.cbos.tas.gov.au/ data/assets/pdf file/0014/405014/Directors-determination-categories-of-building-and-demolition-work-2021.pdf

TOTAL	FLOOR	AREAS

IVI	AIN DWELLING, GROUND FLOOR	
	ALFRESCO	24.90
	LIVING	135.92
	PORCH	2.17
		162.99 m ²

AS & NCC COMPLIANCE

ALL CONSTRUCTION TO BE IN ACCORDANCE WITH NCC 2022 AND APPLICABLE AUSTRALIAN STANDARDS AT TIME OF APPROVAL.
- SLAB IN ACCORDANCE WITH AS 2870. REFER TO ENGINEERS DETAILS

- FOR ALL SLAB DETAILS. BRICK CONTROL JOINTS PROVIDED IN ACCORDANCE WITH NCC 2022.
- ALL STEEL FRAMING TO BE DESIGNED TO AS 4100-2020 OR AS/NZS
- INSULATION TO BE INSTALLED IN ACCORDANCE WITH NCC 2022 AND ALL APPLICABLE AUSTRALIAN STANDARDS.
- TERMITE PROTECTION IN ACCORDANCE WITH AS 3660 AND NCC 2022. GLAZING IN ACCORDANCE WITH AS 1288 AND NCC 2022.
- SMOKE ALARMS IN ACCORDANCE WITH AS 3786 AND NCC 2022. INTERNAL WATERPROOFING IN ACCORDANCE WITH NCC 2022 HOUSING PROVISIONS PART 10.2. EXTERNAL WATERPROOFING IN ACCORDANCE WITH AS 3740 AND AS
- 4654. WET AREA FLOORS TO FALL TO FLOOR WASTES AT MIN. 1:80 AND MAX.
- 1:50 GRADE (IF APPLICABLE). CONDENSATION MANAGEMENT IN ACCORDANCE WITH NCC 2019.
- BUILDING SEALING IN ACCORDANCE WITH NCC 2022. SERVICES IN ACCORDANCE WITH NCC 2022.

OITE OBEQUEIO CONTROL O

- EARTHWORKS IN ACCORDANCE WITH AS 3798-2007. EXTERNAL WALL WRAP (SARKING) IN ACCORDANCE WITH NCC 2022 (IF
- EXHAUST FANS DUCTED TO OUTSIDE AIR (IF APPLICABLE).

SITE SPECIFIC CONTROLS			
CONTROL	DETAILS		
ACID SULPHATE SOIL	NO		
BIODIVERSITY	NO		
BUILDING ENVELOPE	NO		
BUSHFIRE	TBC		
CLIMATE ZONE (NCC)	ZONE 7 - COOL TEMPERATE		
DESIGN WIND CLASSIFICATION	N2 (EXPOSED TBC)		
ESTATE/DEVELOPER GUIDELINES	NO		
FLOOD OVERLAY	NO		
HERITAGE	NO		
LANDSLIP HAZARD	NO		
MINIMUM FLOOR LEVEL	NO		
NATURAL ASSET CODE	NO		
NOISE ATTENUATION	NO		
SALINE SOIL	NO		
SHIELDING FACTOR	PS - PARTIAL SHIELDING		
SITE CLASSIFICATION	M		
SPECIFIC AREA PLAN OVERLAY	NO		
TERRAIN CATEGORY	TC2.5		
TOPOGRAPHIC CLASSIFICATION	T0		
WATERWAY & COASTAL OVERLAY	NO		
WIND REGION	A - NORMAL		
WITHIN 1km CALM SALT WATER	NO		
WITHIN 50km BREAKING SURF	40.00km		
ZONING	VILLAGE		
CROWN OR COUNCIL LAND ON			

BUILDING CONTROLS & COMPLIANCE			
CONTROL	REQUIRED	PROPOSED	
SETBACKS			
FRONT	MIN. 4,500mm	5,453mm	
SIDE A	MIN. 3,000mm	3,000mm	
SIDE B	MIN. 3,000mm	4,450mm	
REAR	MIN. 3,000mm	15,787mm	
BULK & SCALE			
SITE AREA	605m²		
SITE COVERAGE	MAX. 50%	26.94%	
LANDSCAPE			
NO APPLICABLE CONTROLS			
EARTHWORKS			
CUT DEPTH	MAX. 2,000mm	225mm	
ACCESS & AMENITY			
PARKING SPACES	MIN. 2 SPACES	2 SPACES	

ALL

SHEET

4 DRAFT SALE PLAN - CT1 UPDATE

5 PRELIM PLANS - INITIAL ISSUE


2025.09.11

DATE

NVO


DRAWN CHECK

3D PERSPECTIVE

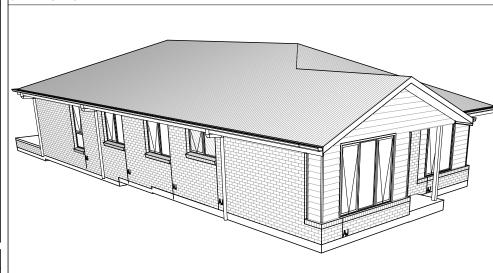

NOTE TO OWNER

THESE PLANS MAY FEATURE WORKS THAT ARE EXCLUDED FROM THE SCOPE OF WORKS WITH THE BUILDER, BUT THEY HAVE BEEN INCLUDED IN THESE DRAWINGS TO ASSIST IN THE OVERALL PLANNING AND ASSESSMENT OF THE BUILDING PROJECT. EXAMPLES OF SOME REGULARLY EXCLUDED WORKS INCLUDE DRIVEWAYS, RETAINING WALLS, SQUAR PANEL SPACING AND SITE DRAINAGE, PLEASE REFER TO YOUR SCOPE OF WORKS AND COLOUR SELECTIONS DOCUMENTATION FOR DETAILS OF INCLUDED WORKS. SOME DETAILS ARE INDICATIVE ONLY FOR EXAMPLE FLOORING, TILING, BRICKWORK AND CLADDING (EXPANSION JOINTS, ORIENTATION AND LAYOUT) AND ARE SUBJECT TO CHANGE.

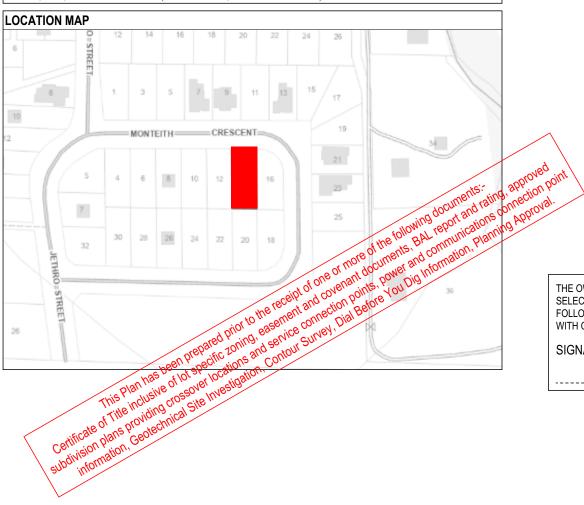

BUILDING INFORMATION

	GROUND FLOOR TOP OF WALL HEIGHT(S)	2445mm
	NOTE: CEILING HEIGHT 45mm LOWER THA	N TOP OF WALL
	ROOF PITCH (U.N.O.)	23.0°
	ELECTRICITY SUPPLY	SINGLE PHASE
	GAS SUPPLY	NONE
	ROOF MATERIAL	SHEET METAL
	ROOF COLOUR	N/A
	WALL MATERIAL	BRICK VENEER CLADDING
>	SLAB CLASSIFICATION	TBC

ΙΝΟΙΤΑ ΙΙΙΡΝΙ

SHEET TITLE:

COVER SHEET

١	INSULATION							
١		ROOF	SARKING UNDER ROOFING					
١		CEILING	R4.1 BATTS (EXCL. GARAGE, ALFRESCO)					
		EXT. WALLS	R2.0 BATTS (EXCL. GARAGE)					
١			WALL WRAP TO ENTIRE HOUSE					
١		INT. WALLS	R2.0 BATTS ADJACENT TO GARAGE AND AS PER PLAN					
١		FLOOR	BIAX SLAB R0.60					

NCC 2022 LIVABLE HOUSING COMPLIANCE

ACCESSIBLE SANITARY COMPARTMENT: ENS ACCESSIBLE SHOWER LOCATION: BATH

GENERAL NOTES:

- THRESHOLD OF ACCESSIBLE SHOWER ENTRY TO BE MAX. 5MM
- -1 EXTERIOR DOOR NOMINATED AS 870 OR GREATER TO ACHIEVE MIN 820MM CLEAR OPENING REFER TO APPLICABLE WET AREA PLANS AND INTERIOR **ELEVATIONS OR LOCATIONS OF REQUIRED WALL** REINFORCEMENT FOR FUTURE GRAB RAIL

INSTALLATION.

THE OWNERS ACKNOWLEDGE THAT THESE CONTRACT PLANS MAY NOT REFLECT ALL THE SELECTIONS THAT HAVE BEEN MADE OR CHANGES REQUESTED. THE OWNERS AGREE THAT FOLLOWING THE COLOUR SELECTIONS VARIATION OR UPDATING OF PLANS, THEY WILL BE PROVIDED WITH CONSTRUCTION PLANS FOR SIGNATURE PRIOR TO COMMENCEMENT OF CONSTRUCTION.

HOUSE CODE

FACADE CODE:

1:100

SHEET No.: SCALES:

1 / 14

H-WNWCYP10SA

F-WNWCYP10RVSDA

SIGNATURE:

DATE:

SUBJECT TO NCC 2022 (1 MAY 2023)

WATERPROOFING & PLUMBING

PLAN ACCEPTANCE BY OWNER SIGNATURE: DATE:

SIGNATURE: DATE:

PLEASE NOTE THAT VARIATIONS WILL NOT BE ACCEPTED AFTER THIS PLAN ACCEPTANCE HAS BEEN SIGNED

© 2025 WILSON HOMES PTY LTD (ABN 96 126 636 897). THIS DRAWING IS AN ORIGINAL ARTISTIC WORK WITHIN THE MEANING OF THE COPYRIGHT ACT 1968 (CTH). WILSON HOMES PTY LTD IS THE OWNER OF COPYRIGHT IN THIS DRAWING. YOU HEREBY AGREE AND UNDERTAKE THAT YOU WILL NOT

COUNCIL:

SOUTHERN MIDLANDS

by Wilson Homes

PRELIMINARY PLAN SET

PRELIMINARY PLAN SET - INITIAL ISSUE

AMENDMENT

No.

IN ANY WAY REPRODUCE, COPY, MODIFY, USE OR TAKE ADVANTAGE OF THE DRAWING TO BUILD A HOUSE BASED ON THIS PLAN (WHETHER IN WHOLE OR IN PART) WITHOUT THE PRIOR WRITTEN CONSENT OF WILSON HOMES PTY LTD.										
SPECIFICATION:		REVISION		DRAWN	CLIENT:	HOUSE DESIGN:				
NOW BY WILSON HOMES	1	DRAFT SALE PLAN - CT1	НМІ	19/08/2025	WILSON COMPLETE	CYPRESS 15				
COPYRIGHT:	2	DRAFT SALE PLAN - CT1 UPDATE	НМІ	20/08/2025	ADDRESS:	FACADE DESIGN:				
© 2025	3	DRAFT SALE PLAN - UPDATED	НМІ	21/08/2025	14 MONTEITH CR, BAGDAD TAS 7030	RIVERSIDE				

HMI 26/08/2025 LOT / SECTION / CT:

NVO 09/09/2025 46 / - / 185527

DO NOT SCALE DRAWINGS, USE FIGURED DIMENSIONS ONLY, CHEC AND VERIFY DIMENSIONS AND I EVELS PRIOR TO THE COMMENCEMENT OF ANY WORK. AL DISCREPANCIES TO BE REPORTED TO THE DRAFTING OFFICE.

714415

APPROX. CUT/FILL

24 TONNES OF EVPORT EILI							
DIFFERENCE	10.72m³	24.12t					
FILL	0.00m³	0.00t					
CUT	10.72m³	24.12t					


 LOT SIZE:
 605m²


 HOUSE (COVERED AREA):
 162.99m²

 SITE COVERAGE:
 26.94%

DEB AREA

DROPPED EI	DROPPED EDGE BEAMS					
NOMINAL HEIGHT (mm)	SURFACE AREA (m²)					
86	0.20					
172	1.15					
257	3.91					
343	5.09					
	10.35 m²					

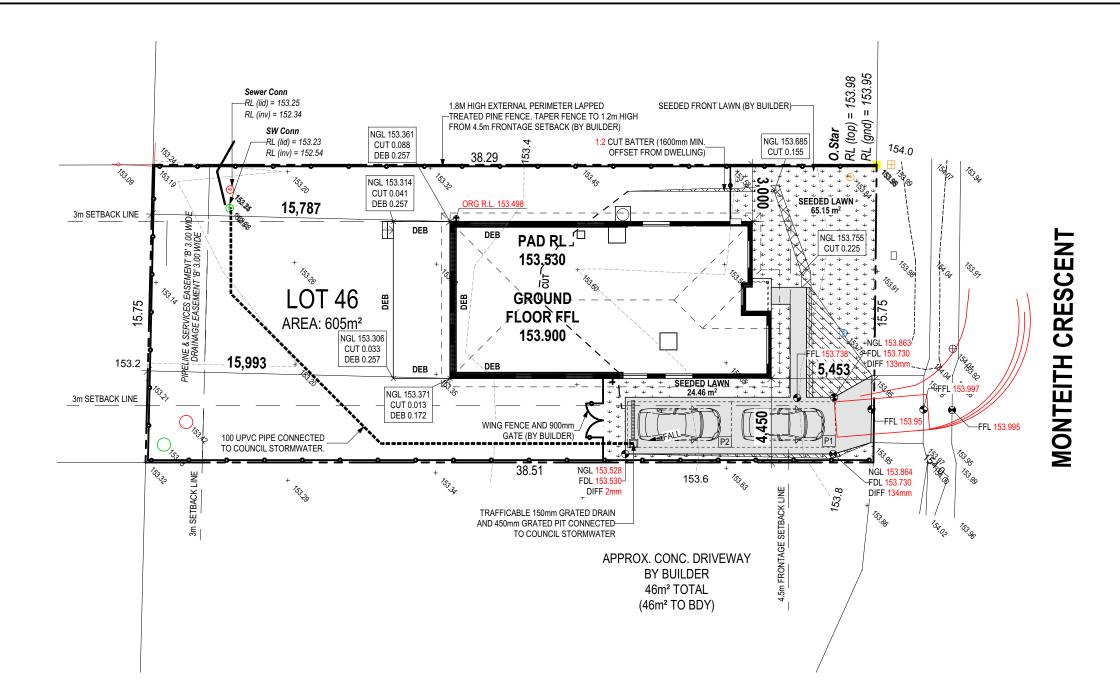

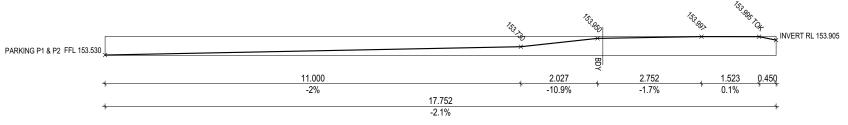

AUSTRALIAN STANDARD DRIVEWAY PROFILE

© 2025 WILSON HOMES PTY LTD (ABN 96 126 636 897). THIS DRAWING IS AN ORIGINAL ARTISTIC WORK WITHIN THE MEANING OF THE COPYRIGHT ACT 1968 (CTH). WILSON HOMES PTY LTD IS THE OWNER OF COPYRIGHT IN THIS DRAWING. YOU HEREBY AGREE AND UNDERTAKE THAT YOU WILL NOT IN ANY WAY REPRODUCE, COPY, MODIFY, USE OR TAKE ADVANTAGE OF THE DRAWING TO BUILD A HOUSE BASED ON THIS PLAN (WHETHER IN WHOLE OR IN PART) WITHOUT THE PRIOR WRITTEN CONSENT OF WILSON HOMES PTY LTD.

SUBJECT TO NCC 2022 (1 MAY 2023)

WATERPROOFING & PLUMBING

PLAN ACCEPTA	ANCE BY OWNER
SIGNATURE:	DATE:
SIGNATURE:	DATE:
PLEASE NOTE THAT VARIAT	IONS WILL NOT BE ACCEPTED

AFTER THIS PLAN ACCEPTANCE HAS BEEN SIGNED




				,			
SPECIFICATION:	REVISION	DRAWN	CLIENT:		HOUSE DESIGN:	HOUSE CODE:	DO NOT SCALE DRAWINGS, USE
NOW BY WILSON HOMES	1 DRAFT SALE PLAN - CT1	HMI 19/08/202 ^f	5 WILSON COMPLET	iΕ	CYPRESS 15	H-WNWCYP10SA	FIGURED DIMENSIONS ONLY. CHECK AND VERIFY DIMENSIONS AND
COPYRIGHT:	2 DRAFT SALE PLAN - CT1 UPDATE	HMI 20/08/2025			FACADE DESIGN:	FACADE CODE:	LEVELS PRIOR TO THE COMMENCEMENT OF ANY WORK. ALL
© 2025	3 DRAFT SALE PLAN - UPDATED	HMI 21/08/2025	5 14 MONTEITH CR, E	3AGDAD TAS 7030	RIVERSIDE	F-WNWCYP10RVSD/	A DISCREPANCIES TO BE REPORTED TO THE DRAFTING OFFICE.
	4 DRAFT SALE PLAN - CT1 UPDATE		5 LOT / SECTION / CT:	COUNCIL:	SHEET TITLE:	SHEET No.: SCALES:	714415
	5 PRELIM PLANS - INITIAL ISSUE	NVO 09/09/202'	5 46 / - / 185527	SOUTHERN MIDLANDS	SITE PLAN	2 / 14 1:200	/ 14410


OWNER TO STABILISE THE SITE ON COMPLETION OF THE BUILD WITH TURF LAWNS, GRASS SEEDS, NATIVE GROUND COVERS AND/ OR MULCH SPREAD TO A DEPTH OF 75-100mm

THE FOLLOWING IS A STANDARD APPROACH. SEDIMENT AND EROSION CONTROL MEASURES WILL BE REVIEWED PRIOR TO COMMENCING WORK AND INSTALLED BASED ON THE OUTCOME OF THAT REVIEW.


1. ALL EROSION AND SEDIMENT CONTROL STRUCTURES TO BE INSPECTED EACH WORKING DAY AND MAINTAINED IN GOOD WORKING ORDER.


- 2. ALL GROUND COVER VEGETATION OUTSIDE THE IMMEDIATE BUILDING AREA TO BE PRESERVED DURING THE BUILDING
- 3. ALL EROSION AND SEDIMENT CONROL MEASURES TO BE INSTALLED PRIOR TO COMMENCEMENT OF MAJOR EARTHWORKS.
- 4. STOCKPILES OF CLAYEY MATERIAL TO BE COVERED WITH AN IMPERVIOUS SHEET. 5. ROOF WATER DOWNPIPES TO BE CONNECTED TO THE PERMAMENT UNDERGROUND STORMWATER DRAINAGE SYSTEM AS SOON AS PRACTICAL AFTER THE ROOF IS LAID.
- 6. DIVERSION DRAINS ARE TO BE CONNECTED TO A LEAGAL DISCHARGE POINT (COUNCIL STORMWATER SYSTEM, WATERCOURSE OR ROAD DRAIN). 7. SEDIMENT RETENTION TRAPS INSTALLED AROUND THE INLETS TO THE STORMWATER SYSTEM TO PREVENT SEDIMENT & OTHER DEBRIS BLOCKING THE DRAINS.

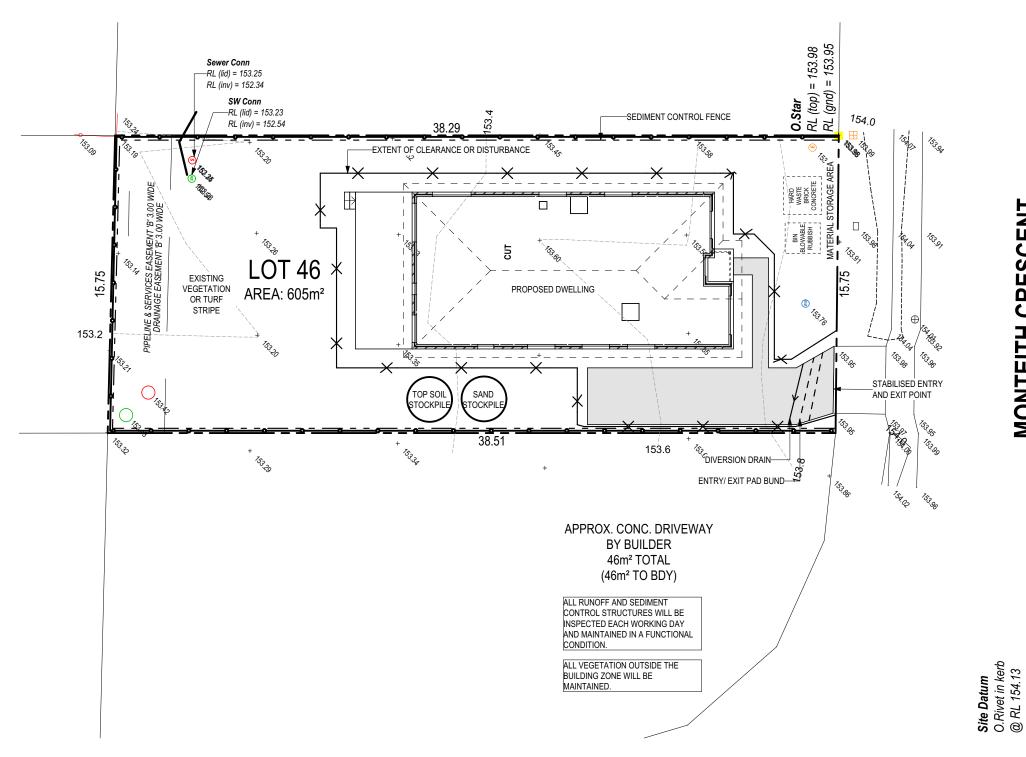

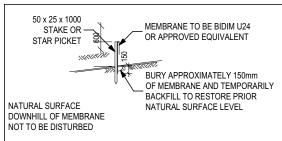

SILT FENCING DETAIL

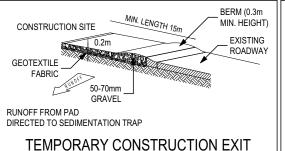

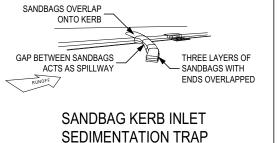

© 2025 WILSON HOMES PTY LTD (ABN 96 126 636 897). THIS DRAWING IS AN ORIGINAL ARTISTIC WORK WITHIN THE MEANING OF THE COPYRIGHT ACT 1968 (CTH). WILSON HOMES PTY LTD IS THE OWNER OF COPYRIGHT IN THIS DRAWING. YOU HEREBY AGREE AND UNDERTAKE THAT YOU WILL NOT



MONTEITH CRESCENT

WATERPROOFING & PLUMBING

PLAN ACCEPTA	ANCE BY OWNER
SIGNATURE:	DATE:
SIGNATURE:	DATE:
	TIONS WILL NOT BE ACCEPTED



	IN AINT WAT REPRODUCE; COPT, MODIFT, USE OR TAKE ADVANTAGE OF THE DRAWING TO BOILD A HOUSE BASED ON THIS PLAN (WHETHER IN WHOLE OR IN PART) WITHOUT THE PRIOR WRITTEN CONSENT OF WILSON HOMES PTT LTD.										
SPECIFICATION:		REVISION	[AWN CLIENT:		HOUSE DESIGN:		HOUSE CODE:	DO NOT SCALE DRAWINGS, USE	1	
NOW BY WILSON HOMES	1	DRAFT SALE PLAN - CT1	НМІ	19/08/2025 WILSON COMPLETE		CYPRESS 15		H-WNWCYP10SA	FIGURED DIMENSIONS ONLY. CHECK AND VERIFY DIMENSIONS AND LEVELS PRIOR TO THE	1.041	
COPYRIGHT:	2	DRAFT SALE PLAN - CT1 UPDATE		20/08/2025 ADDRESS:		FACADE DESIGN:			COMMENCEMENT OF ANY WORK. ALL		
© 2025	3	DRAFT SALE PLAN - UPDATED	НМІ	21/08/2025 14 MONTEITH CR, BAGDAD TAS 7030		RIVERSIDE		F-WNWCYP10RVSDA	DISCREPANCIES TO BE REPORTED TO THE DRAFTING OFFICE.	/ersic	
	4	DRAFT SALE PLAN - CT1 UPDATE		26/08/2025 LOT / SECTION / CT: COUNCIL:		SHEET TITLE:	SHEET No.:		714415	late \	
	5	PRELIM PLANS - INITIAL ISSUE	NVO	09/09/2025 46 / - / 185527 SOUTHERN MID	DLANDS	SOIL & WATER MANAGEMENT PLAN	3 / 14	1:200	1 144 15	Temp	

ANY PART OF THE FASCIA, GUTTERING OR DOWNPIPE THAT IS WITHIN 450mm OF ANY BOUNDARY IS TO BE NON-

ALL EXTERIOR SLABS TO BE GRADED BY CONCRETER TO ACHIEVE APPROX. 1:100 FALL TO OUTSIDE EDGE WITH MAXIMUM CROSSFALL OF 30mm OVER ENTIRE SLAB.

COMBUSTIBLE IN ACCORDANCE WITH NCC 2022

REFER TO SHEET 1 (COVER SHEET) FOR MAIN DWELLING, GROUND FLOOR ALL BUILDING INFORMATION REGARDING ALFRESCO SUSTAINABILITY REQUIREMENTS

PORCH

24.90

135.92

2 17 162.99 m²

GENERAL BUILDING INFORMATION ALL MECHANICAL VENTILATION TO BE DISCHARGED TO OUTDOOR AIR AS PER NCC 2022 REQUIREMENTS


FIRE RESISTANT PLASTERBOARD TO BE INSTALLED BEHIND COOKTOP


ALL GROUND FLOOR BULKHEAD AND SQUARE SET OPENING FRAMES TO BE 2155 ABOVE FFL UNLESS NOTED OTHERWISE

REFER TO WINDOW AND DOOR SCHEDULES FOR FULL DETAILS OF ALL WINDOWS AND DOORS. PLEASE NOTE WINDOW AND DOOR SIZES ARE BASED ON DEPOSIT STAGE AND MAY DIFFER SLIGHTLY TO THE SIZES NOMINATED IN THE SCOPE OF WORKS DUE TO MANUFACTURING CHANGES AT THE TIME OF CONSTRUCTION

FINAL WINDOW AND EXTERIOR DOOR LOCATIONS MAY BE ADJUSTED ON SITE TO SUIT BRICKWORK GAUGE

UNLESS NOTED OTHERWISE ALL ROOMS ARE REFERENCED AS FOLLOWS:

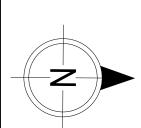

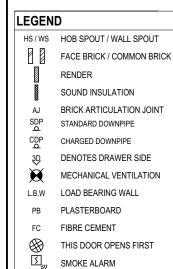


LIFT OFF HINGE

WATER POINT

GAS BAYONET

+

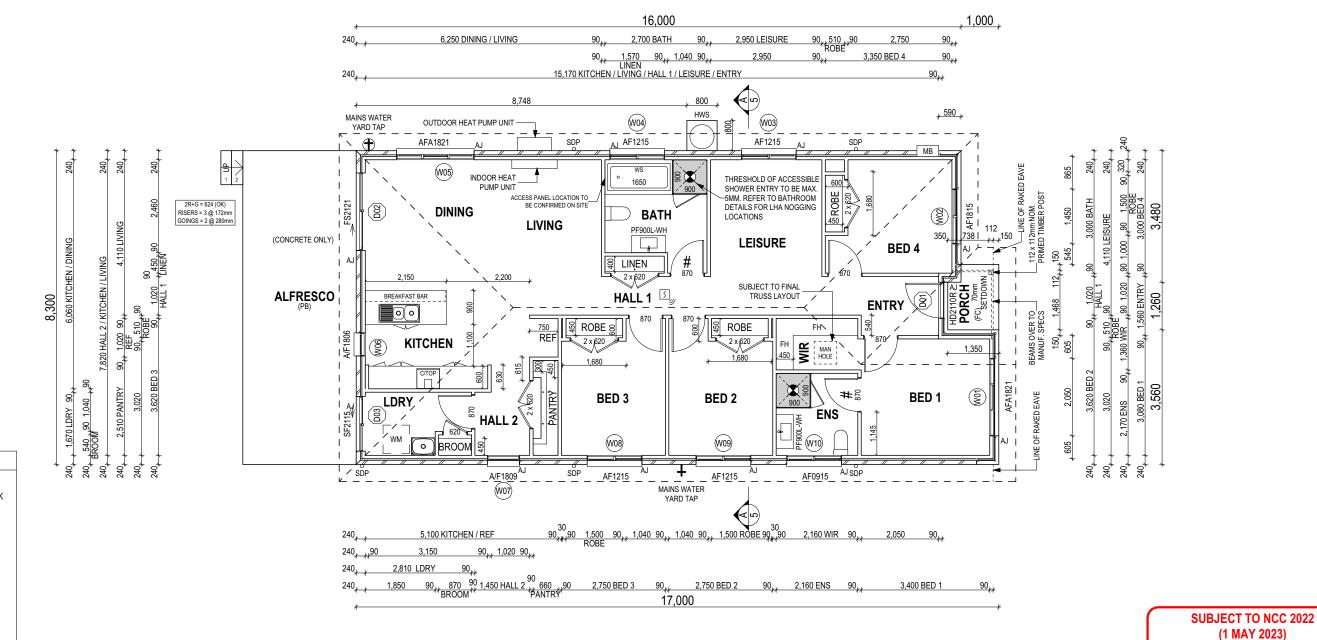

ALL DIMENSIONS ARE FRAME DIMENSIONS © 2025 WILSON HOMES PTY LTD (ABN 96 126 636 897). THIS DRAWING IS AN ORIGINAL ARTISTIC WORK WITHIN THE MEANING OF THE COPYRIGHT ACT 1968 (CTH). WILSON HOMES PTY LTD IS THE OWNER OF COPYRIGHT IN THIS DRAWING. YOU HEREBY AGREE AND UNDERTAKE THAT YOU WILL NOT IN ANY WAY PERPODICE CORY MODIEY USE OR TAKE ADVANTAGE OF THE DRAWING TO RUIL DA HOUSE BASED ON THIS PLAN (WHETHER IN WHOLE OR IN PART) WITHOUT THE PRIOR WRITTEN CONSENT OF WILSON HOMES PTY LTD

PLAN ACCEPT	ANCE BY OWNER
SIGNATURE:	DATE:
SIGNATURE:	DATE:
PLEASE NOTE THAT VARI	ATIONS WILL NOT BE ACCEPTED
AFTER THIS PLAN ACC	EPTANCE HAS BEEN SIGNED

WATERPROOFING & PLUMBING

N	OW
	_{bv} Wilson Homes

	WANT WAT TELL ROOMS, OUT 1, WOULD 1, OCCUPANT AND AN AND AND											
SPECIFICATION:	REVISION	DRAWN CLIENT:		HOUSE DESIGN:	HOUSE CODE:	DO NOT SCALE DRAWINGS, USE	1					
NOW BY WILSON HOMES	1 DRAFT SALE PLAN - CT1	HMI 19/08/2025 WILSON COMPLETE		CYPRESS 15	H-WNWCYP10SA	FIGURED DIMENSIONS ONLY. CHECK AND VERIFY DIMENSIONS AND	140					
COPYRIGHT:		HMI 20/08/2025 ADDRESS:		FACADE DESIGN:	FACADE CODE:	LEVELS PRIOR TO THE COMMENCEMENT OF ANY WORK. ALL						
© 2025	3 DRAFT SALE PLAN - UPDATED	HMI 21/08/2025 14 MONTEITH CR, BAGE	DAD TAS 7030	RIVERSIDE	F-WNWCYP10RVSDA	DISCREPANCIES TO BE REPORTED TO THE DRAFTING OFFICE.	/ersic					
		HMI 26/08/2025 LOT / SECTION / CT:	COUNCIL:	SHEET TITLE:	SHEET No.: SCALES:	714415	late \					
	5 PRELIM PLANS - INITIAL ISSUE	NVO 09/09/2025 46 / - / 185527	SOUTHERN MIDLANDS	GROUND FLOOR PLAN	4 / 14 1:100	<i>1</i> 144 13	Lemp					


SH = SNAP HEADER SILL

SITE CLASSIFICATION

BEDROOM WINDOW OPENINGS ABOVE 2m OFF THE SURFACE BENEATH TO BE RESTRICTED AS REQUIRED BY NCC 11.3.7 (VOLUME TWO)

ROOMS OTHER THAN BEDROOM WINDOW OPENINGS ABOVE 4m OFF THE SURFACE BENEATH TO BE RESTRICTED AS REQUIRED BY NCC 11.3.7 (VOLUME TWO)

REFER TO THE FOLLOWING DETAILS: BRICK COURSING W-BRIC-001

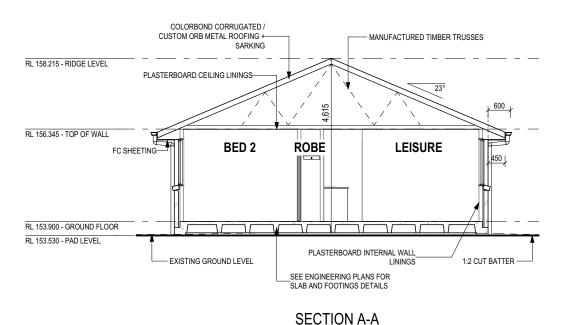


SUBJECT TO NCC 2022 (1 MAY 2023)

WATERPROOFING & PLUMBING

DO NOT SCALE DRAWINGS, USE FIGURED DIMENSIONS ONLY. CHECK AND VERIFY DIMENSIONS AND I EVELS PRIOR TO THE COMMENCEMENT OF ANY WORK. AL DISCREPANCIES TO BE REPORTED TO THE DRAFTING OFFICE.

714415

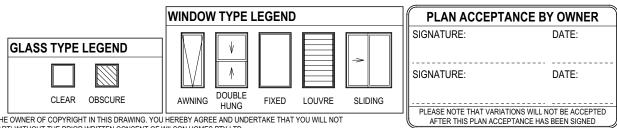

SCALE: 1:100

© 2025 WILSON HOMES PTY LTD (ABN 96 126 636 897). THIS DRAWING IS AN ORIGINAL ARTISTIC WORK WITHIN THE MEANING OF THE COPYRIGHT ACT 1968 (CTH). WILSON HOMES PTY LTD IS THE OWNER OF COPYRIGHT IN THIS DRAWING. YOU HEREBY AGREE AND UNDERTAKE THAT YOU WILL NOT

COLORBOND CORRUGATED /

JAMES HARDIE ALUMINIUM

COLORBOND CORRUGATED /

FBW---

-ALUMINIUM SLIDING DOOR

SOUTH ELEVATION

SCALE: 1:100

-CUSTOM ORB METAL ROOFING + SARKING

D03

EXISTING GROUND LEVEL

EXTERNAL SLIMLINE BOX CORNER

CUSTOM ORB METAL ROOFING +

-ARTICULATED FACE BRICKWORK

JAMES HARDIE SCYON LINEA

180mm CLADDING -42 x 42mm DAR TRIM

1:2 CUT BATTER-

PAINTED FC SHEET OVER DOOR

—ALUMINIUM SLIDING DOOR

112 x 112mm NOM. PRIMED TIMBER



RL 158.215 - RIDGE LEVEL

RL 156.345 - TOP OF WALL

RL 153.900 - GROUND FLOOR RL 153.530 - PAD LEVEL

RL 158.215 - RIDGE LEVEL

RL 156.345 - TOP OF WALL

RL 153.900 - GROUND FLOOR

RL 153.530 - PAD LEVEL

JAMES HARDIE SCYON LINEA

JAMES HARDIE ALUMINIUM

EXTERNAL SLIMLINE BOX CORNER

180mm CLADDING

45mm NOM, MOULDING TO

PAINTED FC SHEET OVER DOOR-

WINDOW JAMES HARDIE ALUMINIUM EXTERNAL SLIMLINE BOX CORNER

45mm NOM. MOULDING TO DOOR-

ARTICULATED FACE BRICKWORK-

D02

NORTH ELEVATION

SCALE: 1:100

IN ANY WAY REPRODUCE, COPY, MODIFY, USE OR TAKE ADVANTAGE OF THE DRAWING TO BUILD A HOUSE BASED ON THIS PLAN (WHETHER IN WHOLE OR IN PART) WITHOUT THE PRIOR WRITTEN CONSENT OF WILSON HOMES PTY LTD.											
ECIFICATION:	REVISION	D	DRAWN	CLIENT:		HOUSE DESIGN:		HOUSE CODE:			
OW BY WILSON HOMES	1 DRAFT SALE PLAN - CT1	НМІ	19/08/2025	WILSON COMPLETE		CYPRESS 15	H-WNWCYP10SA				
PYRIGHT:	2 DRAFT SALE PLAN - CT1 UPDATE	HMI	20/08/2025	ADDRESS:		FACADE DESIGN:		FACADE CODE:			
2025	3 DRAFT SALE PLAN - UPDATED	НМІ	21/08/2025	14 MONTEITH CR, BAGD	AD TAS 7030	RIVERSIDE		F-WNWCYP10RVSDA			
	4 DRAFT SALE PLAN - CT1 UPDATE	HMI	26/08/2025	LOT / SECTION / CT:	COUNCIL:	SHEET TITLE:	SHEET No.:	SCALES:			
	5 PRELIM PLANS - INITIAL ISSUE	NVO	09/09/2025	46 / - / 185527	SOUTHERN MIDLANDS	ELEVATIONS / SECTION	5 / 14	1:100			


ROOMS OTHER THAN BEDROOM WINDOW OPENINGS ABOVE 4m OFF THE SURFACE BENEATH TO BE RESTRICTED AS REQUIRED BY NCC 11.3.7 (VOLUME TWO)

REFER TO THE FOLLOWING DETAILS: BRICK COURSING W-BRIC-001


SITE CLASSIFICATION

SH = SNAP HEADER SILL

TWO)

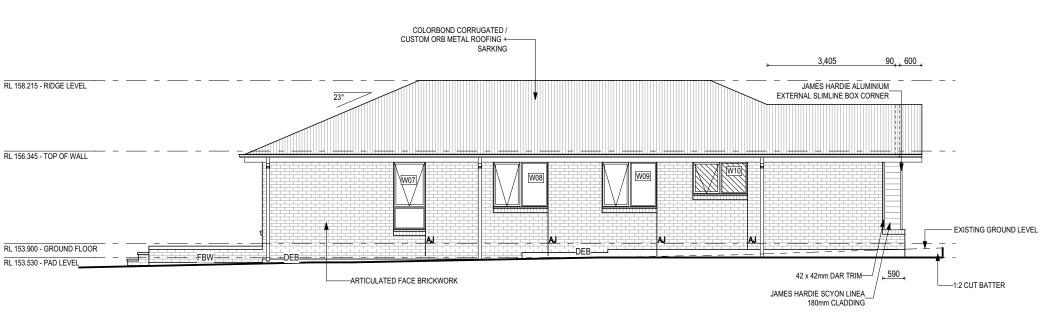


EAST ELEVATION SCALE: 1:100

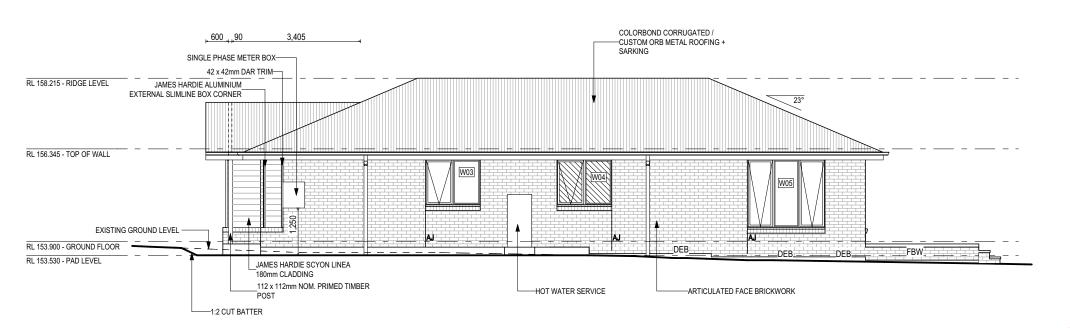

WEST ELEVATION SCALE: 1:100

SUBJECT TO NCC 2022 (1 MAY 2023) WATERPROOFING & PLUMBING

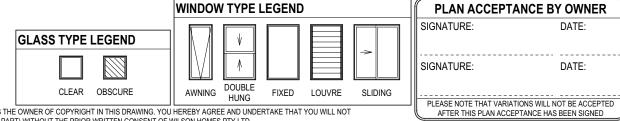

© 2025 WILSON HOMES PTY LTD (ABN 96 126 636 897). THIS DRAWING IS AN ORIGINAL ARTISTIC WORK WITHIN THE MEANING OF THE COPYRIGHT ACT 1968 (CTH). WILSON HOMES PTY LTD IS THE OWNER OF COPYRIGHT IN THIS DRAWING. YOU HEREBY AGREE AND UNDERTAKE THAT YOU WILL NOT



© 2023 WILDON HOWES					N THIS PLAN (WHETHER IN WHOLE OR IN PART) WITHOUT THE PRIOR WRITTEN CO			AFTER THIS PLAN ACCEPTA	AINC
									Ξ
CIFICATION:		REVISION	D	DRAWN CLIENT:		HOUSE DESIGN:		HOUSE CODE:	D
OW BY WILSON HOMES	1	DRAFT SALE PLAN - CT1	НМІ	19/08/2025 WILSON COMPLETE		CYPRESS 15		H-WNWCYP10SA	FIG
PYRIGHT:	2	DRAFT SALE PLAN - CT1 UPDATE	НМІ	20/08/2025 ADDRESS:		FACADE DESIGN:		FACADE CODE:	COM
2025	3	DRAFT SALE PLAN - UPDATED	НМІ	21/08/2025 14 MONTEITH CR, BAGD	AD TAS 7030	RIVERSIDE		F-WNWCYP10RVSDA	DIS
	4			20/00/2020			SHEET No.:	SCALES:	ī
	5	PRELIM PLANS - INITIAL ISSUE	NVO	09/09/2025 46 / - / 185527	SOUTHERN MIDLANDS	ELEVATIONS	6 / 14	1:100	L

DO NOT SCALE DRAWINGS, USE FIGURED DIMENSIONS ONLY, CHECK AND VERIFY DIMENSIONS AND LEVELS PRIOR TO THE COMMENCEMENT OF ANY WORK, ALL DISCREPANCIES TO BE REPORTED TO THE DRAFTING OFFICE.

714415

STOREY	ID	CODE ¹	TYPE	ROOM	HEIGHT	WIDTH	PERIMETER	AREA FRAME (m²) TYPE	BAL SILL TYPE	ORIENT.	GLAZING AREA (m²)	GLAZING TYPE (SINGLE GLAZING U.N.O.)	ADDITIONAL INFORMATION ²	
WINDOW			<u> </u>	-	'					'	'			
GROUND FLOOR	W01	AFA1821	AWNING	BED 1	1,800	2,050	7,700	3.69 ALUMINIUM	N/A NONE	N	2.92	CLEAR, DOUBLE GLAZED	MP 683-683	
GROUND FLOOR	W02	AF1815	AWNING	BED 4	1,800	1,450	6,500	2.61 ALUMINIUM	N/A NONE	N	2.13	CLEAR, DOUBLE GLAZED	MP 725	
GROUND FLOOR	W03	AF1215	AWNING	LEISURE	1,200	1,450	5,300	1.74 ALUMINIUM	N/A ANGLED	W	1.38	CLEAR, DOUBLE GLAZED	MP 725	
GROUND FLOOR	W04	AF1215	AWNING	BATH	1,200	1,450	5,300	1.74 ALUMINIUM	N/A ANGLED	W	1.38	OBSCURE, DOUBLE GLAZED, TOUGHENED	MP 725	
GROUND FLOOR	W05	AFA1821	AWNING	DINING	1,800	2,050	7,700	3.69 ALUMINIUM	N/A ANGLED	W	2.92	CLEAR, DOUBLE GLAZED	MP 683-683	
GROUND FLOOR	W06	A/F1806	AWNING	KITCHEN	1,800	610	4,820	1.10 ALUMINIUM	N/A ANGLED	S	0.80	CLEAR, DOUBLE GLAZED	BP 600	
GROUND FLOOR	W07	A/F1809	AWNING	HALL 2	1,800	850	5,300	1.53 ALUMINIUM	N/A ANGLED	Е	1.19	CLEAR, DOUBLE GLAZED	BP 600	
GROUND FLOOR	W08	AF1215	AWNING	BED 3	1,200	1,450	5,300	1.74 ALUMINIUM	N/A ANGLED	Е	1.38	CLEAR, DOUBLE GLAZED	MP 725	
GROUND FLOOR	W09	AF1215	AWNING	BED 2	1,200	1,450	5,300	1.74 ALUMINIUM	N/A ANGLED	Е	1.38	CLEAR, DOUBLE GLAZED	MP 725	
GROUND FLOOR	W10	AF0915	AWNING	ENS	857	1,450	4,614	1.24 ALUMINIUM	N/A ANGLED	E	0.95	OBSCURE, DOUBLE GLAZED, TOUGHENED	MP 725	
							57,834 mm	20.82			16.42			
DOOR								•		•				
GROUND FLOOR	D01	HD2110R	SWINGING	ENTRY	2,100	970	6,140	2.04 ALUMINIUM	N/A SNAP HEADER	N	1.41	N/A		
GROUND FLOOR	D02	FS2121	SLIDING	DINING	2,100	2,050	8,300	4.31 ALUMINIUM	N/A SNAP HEADER	S	3.79	CLEAR, DOUBLE GLAZED, TOUGHENED		
GROUND FLOOR	D03	SF2115	SLIDING	LDRY	2,100	1,450	7,100	3.05 ALUMINIUM	N/A SNAP HEADER	S	2.59	CLEAR, DOUBLE GLAZED, TOUGHENED		
							21,540 mm	9.39			7.79			
							79,374 mm	30.21			24.21			

No BAL / BAL 12.5			
Window Type	WERS Code	U Value	SHG
Sliding Window	DOW-022-003	2.9	0.64
Awning Window	DOW-005-001	3.9	0.58
Fixed External Window	DOW-038-001	3.03	0.71
Sliding Door	DAR-034-001	3.97	0.63
Stacking Door	DAR-034-001	3.97	0.63
Hinged Door	DOW-017-001	4.1	0.55
Bi-Fold Door	DOW-020-001	4.1	0.54
BAL 19			
Window Type	WERS Code	U Value	SHG
Sliding Window	TND-034-001	3.1	0.61
Awning Window	STG-001-066	3.91	0.54
Fixed External Window	DOW-038-005	3.02	0.66
Sliding Door	AUW-009-009	4.03	0.58
Stacking Door	AUW-009-009	4.03	0.58
Hinged Door	GRN-009-001	4.25	0.53
Bi-Fold Door	DOW-020-001	4.1	0.54
BAL 29			
Window Type	WERS Code	U Value	SHG
Sliding Window	TND-034-001	3.1	0.61
Awning Window	STG-001-066	3.91	0.54
Fixed External Window	DOW-038-005	3.02	0.66
Sliding Door	AMJ-007-005	4.03	0.59
Stacking Door	AMJ-007-005	4.03	0.59
Hinged Door	GRN-009-001	4.29	0.53

Windows supplied MUST HAVE Uw better and or equal to stated figures and SHGC within +/- 5% of stated figures. Restricted windows to have their openability restricted as per N.C.C 11.3.6.

PICTURE, TV RECESS AND SS WINDOW OPENINGS QTY TYPE HEIGHT WIDTH AREA (m²)

870 N/A NOTE: INTERNAL DOORS TO WET AREAS WITH MECHANICAL VENTILATION TO BE UNDERCUT 20mm

HEIGHT WIDTH GLAZING TYPE ADDITIONAL INFORMATION

LIFT-OFF HINGES

2,040

2,040

2,040

2,040

1,240 N/A

620 N/A

870 N/A

REFER TO SHEET 1 (COVER SHEET) FOR ALL BUILDING INFORMATION REGARDING:
- SUSTAINABILITY REQUIREMENTS
- SITE CLASSIFICATION
- GENERAL BUILDING INFORMATION

GROUND FLOOR 2 870

GROUND FLOOR 5

GROUND FLOOR 1

GROUND FLOOR 5

STOREY

DOOR

by Wilson Homes	
	© 202
	COPYRIG
	NOW
	SPECIFIC

INTERIOR WINDOW & DOOR SCHEDULE

QTY CODE

2 x 620

620

870

TYPE

SWINGING

SWINGING

SWINGING

SWINGING


© 2025 WILSON HOMES				.CT 1968 (CTH). WILSON HOMES PTY LTD IS THE OWNER OF COPYRIGHT IN THIS D ON THIS PLAN (WHETHER IN WHOLE OR IN PART) WITHOUT THE PRIOR WRITTEN (AFTER THIS PLAN ACCEPT	ANCE HAS BEEN SIG
SPECIFICATION:	REVISION	1	DRAWN CLIENT:		HOUSE DESIGN:		HOUSE CODE:	DO NOT SCALE DRA
NOW BY WILSON HOMES	1 DRAFT SALE PLAN - CT1	НМІ	19/08/2025 WILSON COMPLETE		CYPRESS 15		H-WNWCYP10SA	AND VERIFY DIMEN
COPYRIGHT:	2 DRAFT SALE PLAN - CT1 UPDATE	нмі	20/08/2025 ADDRESS:		FACADE DESIGN:		FACADE CODE:	LEVELS PRIOR COMMENCEMENT OF
© 2025	3 DRAFT SALE PLAN - UPDATED	НМІ	21/08/2025 14 MONTEITH CR, BAGE	DAD TAS 7030	RIVERSIDE		F-WNWCYP10RVSDA	DISCREPANCIES TO TO THE DRAFTIN
	4 DRAFT SALE PLAN - CT1 UPDATE		26/08/2025 LOT / SECTION / CT:	COUNCIL:	SHEET TITLE:	SHEET No.:	SCALES:	7144
	5 PRELIM PLANS - INITIAL ISSUE	NVO	09/09/2025 46 / - / 185527	SOUTHERN MIDLANDS	WINDOW & DOOR SCHEDULES	7 / 14		/ 144

SUBJECT TO NCC 2022 (1 MAY 2023) WATERPROOFING & PLUMBING

PLAN ACCEPT	ANCE BY OWNER
SIGNATURE:	DATE:
SIGNATURE:	DATE:
PLEASE NOTE THAT VARIA	TIONS WILL NOT BE ACCEPTED
AFTER THIS PLAN ACCE	PTANCE HAS BEEN SIGNED

LE DRAWINGS, USE NSIONS ONLY. CHECK 'DIMENSIONS AND PRIOR TO THE NT OF ANY WORK. ALL ES TO BE REPORTED RAFTING OFFICE.

16,900 1,000 ,

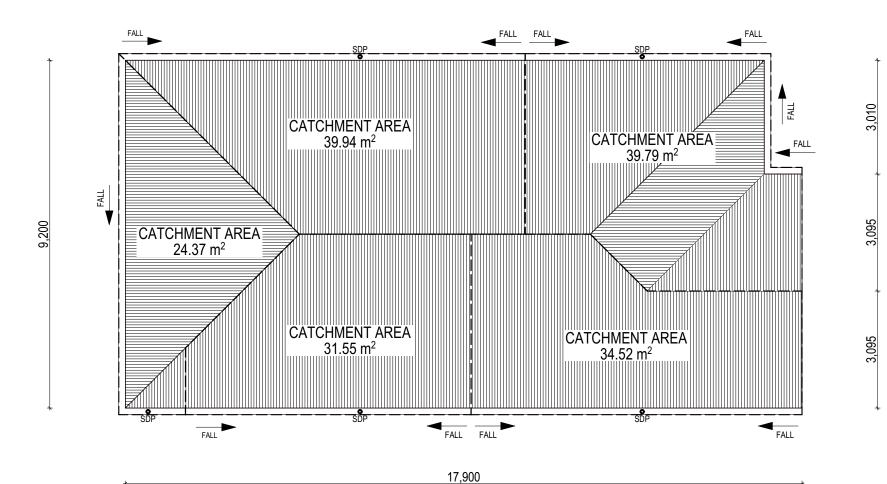

WHERE DOWNPIPES ARE FURTHER THAN 1.2m AWAY FROM VALLEY REFER TO N.C.C. 7.3.5(2)

POSITION AND QUALITY OF DOWNPIPES ARE NOT TO BE ALTERED WITHOUT CONSULTATION WITH DESIGNER.

AREA'S SHOWN ARE SURFACE AREAS/ CATCHMENT AREAS, NOT PLAN AREAS

Roofi	ng Data	
	161.67	Flat Roof Area (excluding gutter and slope factor) (m²)
	175.63	Roof Surface Area (includes slope factor, excludes gutter) (m²)
Down	pipe roof	calculations (as per AS/NZA3500.3:2021)
Ah	170.17	Area of roof catchment (including 115mm Slotted Quad Gutter) (m²)
Ac	205.91	Ah x Catchment Area Multiplier for slope (Table 3.4.3.2 from AS/NZS 3500.3:2021) (1.21 for 23° pitch) (m²)
Ae	6300	Cross sectional area of 57 x 115 Slotted Quad Gutter (mm ²)
DRI	86	Design Rainfall Intensity (determined from Table E1 from AS/NZS 3500.3:2021)
Acdp	64	Catchment area per Downpipe (determined from Figure 3.5(A) from AS/NZS 3500.3:2021) (m²)
Required Downpipes	3.22	Ac / Acdp
Downpipes Provided	5	

SOFFIT EAVE VENT PROPOSED LOCATION TO BE MIN. 1M FROM CORNER JOINT

SUBJECT TO NCC 2022 (1 MAY 2023)
WATERPROOFING & PLUMBING

PLAN ACCEPT	ANCE BY OWNER
SIGNATURE:	DATE:
SIGNATURE:	DATE:
PLEASE NOTE THAT VARIA	TIONS WILL NOT BE ACCEPTED
AFTER THIS PLAN ACCE	EPTANCE HAS BEEN SIGNED

© 2025 WILSON HOMES PTY LTD (ABN 96 126 636 897). THIS DRAWING IS AN ORIGINAL ARTISTIC WORK WITHIN THE MEANING OF THE COPYRIGHT ACT 1968 (CTH). WILSON HOMES PTY LTD IS THE OWNER OF COPYRIGHT IN THIS DRAWING. YOU HEREBY AGREE AND UNDERTAKE THAT YOU WILL NOT



		IN ANT WAT REPRODUCE, COPT, WODIFT, USE OR TAKE	ADVANTAGE OF THE DRAWING TO BUILD A HOU	USE BASED ON THIS PLAIN (WHETHER IN WHOLE OR IN PART) WITHOUT THE PI	KIOK WKITTEN CO	DINSENT OF WILSON HOWES PTT LTD.				i E
SPECIFICATION:	\Box	REVISION	DRAWN CLIENT:			HOUSE DESIGN:		HOUSE CODE:	DO NOT SCALE DRAWINGS, USE	1
NOW BY WILSON HOMES	1	DRAFT SALE PLAN - CT1	HMI 19/08/2025 WILSON COMPL	LETE		CYPRESS 15		H-WNWCYP10SA	FIGURED DIMENSIONS ONLY. CHECK AND VERIFY DIMENSIONS AND	.041
COPYRIGHT:	2	DRAFT SALE PLAN - CT1 UPDATE	HMI 20/08/2025 ADDRESS:			FACADE DESIGN:			LEVELS PRIOR TO THE COMMENCEMENT OF ANY WORK. ALL DISCREPANCIES TO BE REPORTED	
© 2025	3	DRAFT SALE PLAN - UPDATED	нмі 21/08/2025 14 MONTEITH CF	R, BAGDAD TAS 7030		RIVERSIDE		F-WNWCYP10RVSDA	TO THE DRAFTING OFFICE.	Versic
	4		HMI 26/08/2025 LOT / SECTION / CT:	COUNCIL:		SHEET TITLE:	SHEET No.:		714415	olate
1	5	PRELIM PLANS - INITIAL ISSUE	NVO 09/09/2025 46 / - / 185527	SOUTHERN MIDLANDS		ROOF DRAINAGE PLAN	8 / 14	1:100	1 144 13	Temp

FLOOR TILES SHOWN ON PLAN DO NOT INDICATE THE SIZE OR JOINT LOCATIONS OF THE ACTUAL FLOOR TILES.
TIMBER FLOORING SHOWN ON PLAN DOES NOT INDICATE THE BOARD SIZE OR DIRECTION OF THE ACTUAL FLOORING.

COVERINGS LEGEND

NO COVERING

COVER GRADE CONCRETE

CARPET

LAMINATE

TILE (STANDARD WET AREAS)

TILE (UPGRADED AREAS)

DECKING



(1 MAY 2023)

WATERPROOFING & PLUMBING

PLAN ACCEPTANCE BY OWNER					
SIGNATURE:	DATE:				
SIGNATURE:	DATE:				
	TIONS WILL NOT BE ACCEPTED				

DO NOT SCALE DRAWINGS, USE FIGURED DIMENSIONS ONLY. CHECK

FIGURED DIMENSIONS ONLY. CHECK AND VERIFY DIMENSIONS AND LEVELS PRIOR TO THE COMMENCEMENT OF ANY WORK. AL DISCREPANCIES TO BE REPORTED TO THE DRAFTING OFFICE.


714415

© 2025 WILSON HOMES PTY LTD (ABN 96 126 636 897). THIS DRAWING IS AN ORIGINAL ARTISTIC WORK WITHIN THE MEANING OF THE COPYRIGHT ACT 1968 (CTH). WILSON HOMES PTY LTD IS THE OWNER OF COPYRIGHT IN THIS DRAWING. YOU HEREBY AGREE AND UNDERTAKE THAT YOU WILL NOT




	IN ANY WAY DEDDODUCE CODY MODIEV LICE OF TAKE A	ADV/ANT	ACE OF THE DRAWING TO BUILD A HOUSE BACED ON	THE DIAM WHITTED IN WHOLE OR IN DART WITHOUT THE PRIOR WRITTEN OF	ONCENT OF WILCON HOMES DIVITE		71 TERT THIS I BRITTOSEL TO	
	IN ANT WAT REPRODUCE, COPT, MODIFT, USE OR TAKE A	ADVANI	AGE OF THE DRAWING TO BUILD A HOUSE BASED OF	N THIS PLAN (WHETHER IN WHOLE OR IN PART) WITHOUT THE PRIOR WRITTEN CO	UNSENT OF WILSON HOMES PTY LTD.			_
CATION:	REVISION	D	RAWN CLIENT:		HOUSE DESIGN:		HOUSE CODE:	
BY WILSON HOMES	1 DRAFT SALE PLAN - CT1	_	19/08/2025 WILSON COMPLETE		CYPRESS 15		H-WNWCYP10SA	FIC
NIT.					FACADE DESIGN:		FACADE CODE:	1
5 T I :			20/08/2025 ADDRESS:					CO
5			21/08/2025 14 MONTEITH CR, BAGD	AD TAS 7030	RIVERSIDE	_	F-WNWCYP10RVSDA	_
			20/00/2020		SHEET TITLE:	SHEET No.:		ı
	5 PRELIM PLANS - INITIAL ISSUE	NVO	09/09/2025 46 / - / 185527	SOUTHERN MIDLANDS	FLOOR COVERINGS	9 / 14	1:100	1

ELEVATION A SCALE: 1:50

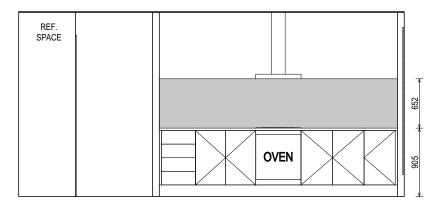


ELEVATION C SCALE: 1:50

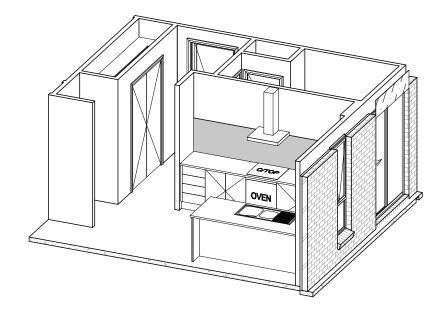


3 DRAFT SALE PLAN - UPDATED

5 PRELIM PLANS - INITIAL ISSUE


4 DRAFT SALE PLAN - CT1 UPDATE

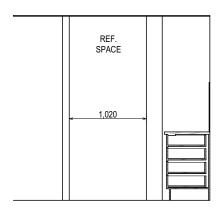


ELEVATION B SCALE: 1:50

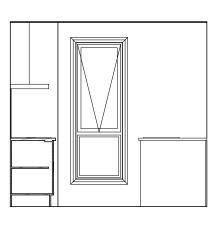

ELEVATION D SCALE: 1:50

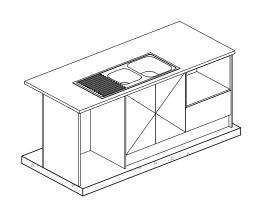

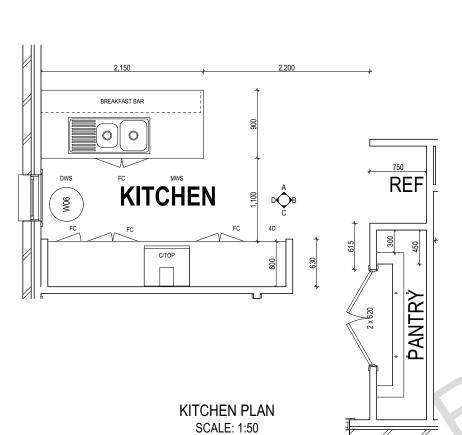

RIVERSIDE

KITCHEN DETAILS

SHEET TITLE:

SUBJECT TO NCC 2022 (1 MAY 2023) WATERPROOFING & PLUMBING

REFER TO SHEET 1 (COVER SHEET) FOR ALL BUILDING INFORMATION REGARDING: SUSTAINABILITY REQUIREMENTS SITE CLASSIFICATION GENERAL BUILDING INFORMATION

DETAILS DEPICTED ON THIS SHEET ARE A REPRESENTATION ONLY. JOINER MAY ADJUST CABINETRY AS REQUIRED.

PLAN ACCEPTANCE BY OWNER SIGNATURE: DATE: SIGNATURE: DATE: PLEASE NOTE THAT VARIATIONS WILL NOT BE ACCEPTED AFTER THIS PLAN ACCEPTANCE HAS BEEN SIGNED

ALL DIMENSIONS ARE FRAME DIMENSIONS

© 2025 WILSON HOMES PTY LTD (ABN 96 126 636 897). THIS DRAWING IS AN ORIGINAL ARTISTIC WORK WITHIN THE MEANING OF THE COPYRIGHT ACT 1968 (CTH). WILSON HOMES PTY LTD IS THE OWNER OF COPYRIGHT IN THIS DRAWING. YOU HEREBY AGREE AND UNDERTAKE THAT YOU WILL NOT

SOUTHERN MIDLANDS

by Wilson Homes	
	© 2025
	COPYRIGHT:
	NOM B
	SPECIFICATI

310113	IN ANY WAY REPRODUCE, COPY, MODIFY, USE OR TAKE ADVANTAGE OF THE DRAWING TO BUILD A HOUSE BASED ON THIS PLAN (WHETHER IN WHOLE OR IN PART) WITHOUT THE PRIOR WRITTEN CONSENT OF WILSON HOMES PTY LTD.					
			Touris.	Tuesda and the same of the sam		
SPECIFICATION:	REVISION	[DRAWN CLIENT:	HOUSE DESIGN:		
NOW BY WILSON HOMES	1 DRAFT SALE PLAN - CT1	НМІ	19/08/2025 WILSON COMPLETE	CYPRESS 15		
COPYRIGHT:	2 DRAFT SALE PLAN - CT1 UPDATE	НМІ	20/08/2025 ADDRESS:	FACADE DESIGN:		

HMI 21/08/2025 14 MONTEITH CR, BAGDAD TAS 7030

HMI 26/08/2025 LOT / SECTION / CT:

NVO 09/09/2025 46 / - / 185527

DO NOT SCALE DRAWINGS, USE FIGURED DIMENSIONS ONLY. CHECK AND VERIPY DIMENSIONS AND LEVELS PRIOR TO THE COMMENCEMENT OF ANY WORK. ALL DISCREPANCIES TO BE REPORTED TO THE DRAFTING OFFICE. HOUSE CODE H-WNWCYP10SA FACADE CODE: F-WNWCYP10RVSDA SHEET No.: SCALES: 714415

10 / 14 | 1:50

REFER TO THE FOLLOWING DETAILS: VANITY DETAILS G-VANI-001
WINDOW OVER BATH HOB D-WIND-ALU001

SQUARE SET WINDOWS G-WIND-SSET02 FULL HEIGHT TILING D-LINI-WETA

LOCATIONS


DETAILS DEPICTED ON THIS SHEET ARE A REPRESENTATION ONLY




HOT TAP COLD TAP HOB SPOUT WALL SPOUT STOP COCK TOILET ROLL HOLDER

HT CT HS WS SC TRH TR-S TOWEL RAIL - SINGLE TR-D TOWEL RAIL - DOUBLE TL TOWEL LADDER TH TOWEL HOLDER TR TOWEL RACK TMB TUMBLER HOLDER RNG TOWEL RING

RH ROBE HOOK SHLF SHELF SR SHAMPOO RECESS SOAP SOAP HOLDER

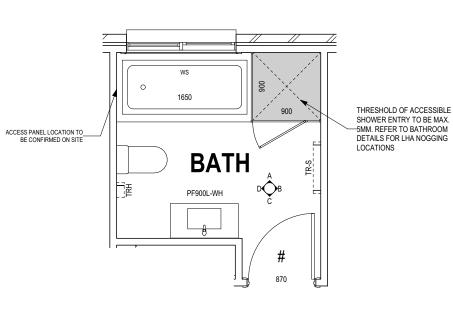

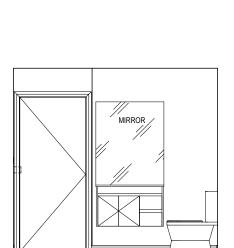

ELEVATION A

SCALE: 1:50


600 x 150 NOGGINGS . 800-810

HEIGHT (CTR LINE). OFFSET 250mm FROM WALL

600 x 150 NOGGINGS . 800-

810 HEIGHT (CTR LINE).-CENTRED TO ROSE

ELEVATION C SCALE: 1:50

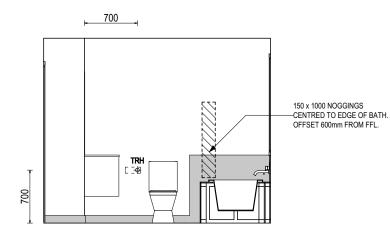

ELEVATION B

SCALE: 1:50

ELEVATION D SCALE: 1:50

BATHROOM PLAN SCALE: 1:50

				Ι.		
SHAMPOO	RECESS SIZE	STRUCTURAL	UCTURAL DIMENSIONS			
		WIDTH	HEIGHT			
"SMALL"	470 x 380mm	548mm	446mm	1		
"MEDIUM"	800 x 380mm	878mm	446mm			
"LARGE"	1500 x 380mm	1578mm	446mm			
REFER WILSON HOMES' DETAIL G-WETA-TILEO1 FOR						

FURTHER DETAIL PRIOR TO INSTALLATION.

SUBJECT TO NCC 2022 (1 MAY 2023)

WATERPROOFING & PLUMBING

SIGNATURE:	DATE:
SIGNATURE:	DATE:
	<u>_</u> .

ALL DIMENSIONS ARE FRAME DIMENSIONS

© 2025 WILSON HOMES PTY LTD (ABN 96 126 636 897). THIS DRAWING IS AN ORIGINAL ARTISTIC WORK WITHIN THE MEANING OF THE COPYRIGHT ACT 1968 (CTH). WILSON HOMES PTY LTD IS THE OWNER OF COPYRIGHT IN THIS DRAWING. YOU HEREBY AGREE AND UNDERTAKE THAT YOU WILL NOT

NOW	SPE NC COF
by Wilson Homes	

600 x 150 NOGGINGS CENTRED TO BATH. OFFSET-

175mm FROM TOP OF BATH

IN AIM TWAT REPRODUCE, COPT, MODIFT, USE OF TARE ADVANTAGE OF THE DRAWING TO BOILD A HOUSE BASED ON THIS PLAN (WHETHER IN WHOLE OR IN PART) WITHOUT THE PRIOR WRITTEN CONSENT OF WILSON HOMES PTT LTD.											
	SPECIFICATION:		REVISION	0	DRAWN CLIENT:		HOUSE DESIGN:		HOUSE CODE:	DO NOT SCALE DRAWINGS, USE	
	NOW BY WILSON HOMES	1	DRAFT SALE PLAN - CT1	НМІ	19/08/2025 WILSON COMPLETE		CYPRESS 15		H-WNWCYP10SA	FIGURED DIMENSIONS ONLY. CHECK AND VERIFY DIMENSIONS AND LEVELS PRIOR TO THE	
	COPYRIGHT:	2			20/08/2025 ADDRESS:		FACADE DESIGN:		FACADE CODE:	COMMENCEMENT OF ANY WORK. ALI	
	© 2025	3	DRAFT SALE PLAN - UPDATED	НМІ	21/08/2025 14 MONTEITH CR, BAGD	OAD TAS 7030	RIVERSIDE		F-WNWCYP10RVSDA	DISCREPANCIES TO BE REPORTED TO THE DRAFTING OFFICE.	
		4	DRAFT SALE PLAN - CT1 UPDATE	HMI	-5.75	COUNCIL:	SHEET TITLE:	SHEET No.:		711115	
		5	PRELIM PLANS - INITIAL ISSUE	NVO	09/09/2025 46 / - / 185527	SOUTHERN MIDLANDS	BATHROOM DETAILS	11 / 14	1:50	714415	

1,175

RSHR RAIL SHOWER

ELBW

CT

HS

WS

SC

TRH

TH

RH

ROSE SHOWER ROSE

HOT TAP

COLD TAP

HOB SPOUT

WALL SPOUT

STOP COCK

TL TOWEL LADDER

RNG TOWEL RING

SOAP SOAP HOLDER

SHLF SHELF SR

ROBE HOOK

TOWEL HOLDER TR TOWEL RACK

CONNECTION MIX MIXER TAP HT

REFER TO THE FOLLOWING DETAILS: VANITY DETAILS G-VANI-001
WINDOW OVER BATH HOB D-WIND-ALU001

STANDARD BATH HOB D-WETA-BATH003
WET AREA TILING LAYOUTS D-WETA-TILE002

SQUARE SET WINDOWS G-WIND-SSET02 FULL HEIGHT TILING D-LINI-WETA

900

RIVERSIDE


ENSUITE DETAILS

SHEET TITLE:

ENSUITE PLAN SCALE: 1:50

470 x 380mm 800 x 380mm 878mm 446mm 1500 x 380mm 1578mm REFER WILSON HOMES' DETAIL G-WETA-TILE01 FOR FURTHER DETAIL PRIOR TO INSTALLATION.

SHAMPOO RECESS SIZE | STRUCTURAL DIMENSIONS

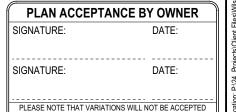

SUBJECT TO NCC 2022 (1 MAY 2023) WATERPROOFING & PLUMBING

"MEDIUM"

HOUSE CODE

FACADE CODE:

SHEET No.: SCALES:


12 / 14 | 1:50

H-WNWCYP10SA


F-WNWCYP10RVSDA



450 415

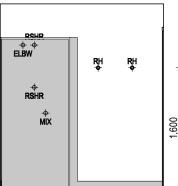


ELEVATION A SCALE: 1:50

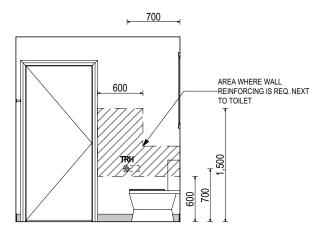

ELEVATION B SCALE: 1:50



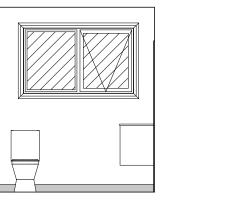


3 DRAFT SALE PLAN - UPDATED

4 DRAFT SALE PLAN - CT1 UPDATE

5 PRELIM PLANS - INITIAL ISSUE

ELEVATION C SCALE: 1:50

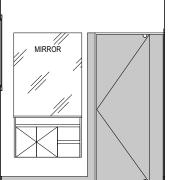

ELEVATION D SCALE: 1:50

© 2025 WILSON HOMES PTY LTD (ABN 96 126 636 897). THIS DRAWING IS AN ORIGINAL ARTISTIC WORK WITHIN THE MEANING OF THE COPYRIGHT ACT 1968 (CTH). WILSON HOMES PTY LTD IS THE OWNER OF COPYRIGHT IN THIS DRAWING. YOU HEREBY AGREE AND UNDERTAKE THAT YOU WILL NOT

HMI 26/08/2025 LOT / SECTION / CT:

NVO 09/09/2025 46 / - / 185527

HMI 21/08/2025 14 MONTEITH CR, BAGDAD TAS 7030

NO	
	RIGHT
SPEC	W B
	IFICAT


ALL DIMENSIONS ARE FRAME DIMEN	ISIONS © 2025 WILSON HOMES	2025 WILSON HOMES PTY LTD (ABM 96 126 636 897). THIS DRAWING IS AN ORIGINAL ARTISTIC WORK WITHIN THE MEANING OF THE COPYRIGHT ACT 1968 (CTH). WILSON HOMES PTY LTD IS THE OWNER OF COPYRIGHT IN THIS DRAWING. YOU HEREBY AGREE AND UNDERTAKE THAT YOU WILL NOT IN ANY WAY REPRODUCE, COPY, MODIFY, USE OR TAKE ADVANTAGE OF THE DRAWING TO BUILD A HOUSE BASED ON THIS PLAN (WHETHER IN WHOLE OR IN PART) WITHOUT THE PRIOR WRITTEN CONSENT OF WILSON HOMES PTY LTD.						
	SPECIFICATION:	REVISION	DR	AWN	CLIENT:	HOUSE DESIGN:		
	NOW BY WILSON HOMES	1 DRAFT SALE PLAN - CT1	HMI 1	19/08/2025	WILSON COMPLETE	CYPRESS 15		
	COPYRIGHT:	2 DRAFT SALE PLAN - CT1 UPDATE	HMI 2	20/08/2025	ADDRESS:	FACADE DESIGN:		

SOUTHERN MIDLANDS


DO NOT SCALE DRAWINGS, USE FIGURED DIMENSIONS ONLY. CHECK AND VERIFY DIMENSIONS AND LEVELS PRIOR TO THE COMMENCEMENT OF ANY WORK. AL DISCREPANCIES TO BE REPORTED TO THE DRAFTING OFFICE. 714415




ELEVATION A SCALE: 1:50

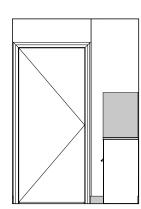


ELEVATION B SCALE: 1:50

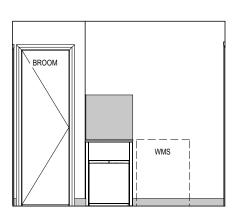

ELEVATION C SCALE: 1:50

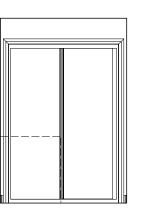

ELEVATION D SCALE: 1:50

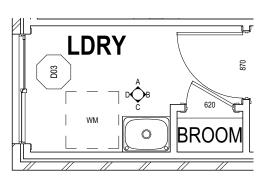

LAUNDRY PLAN SCALE: 1:50

SUBJECT TO NCC 2022 (1 MAY 2023)

WATERPROOFING & PLUMBING

PLAN ACCEPTANCE BY OWNER SIGNATURE: DATE: SIGNATURE: DATE: PLEASE NOTE THAT VARIATIONS WILL NOT BE ACCEPTED AFTER THIS PLAN ACCEPTANCE HAS BEEN SIGNED


ALL DIMENSIONS ARE FRAME DIMENSIONS

© 2025 WILSON HOMES PTY LTD (ABN 96 126 636 897). THIS DRAWING IS AN ORIGINAL ARTISTIC WORK WITHIN THE MEANING OF THE COPYRIGHT ACT 1968 (CTH). WILSON HOMES PTY LTD IS THE OWNER OF COPYRIGHT IN THIS DRAWING. YOU HEREBY AGREE AND UNDERTAKE THAT YOU WILL NOT IN ANY WAY REPRODUCE, COPY, MODIFY, USE OR TAKE ADVANTAGE OF THE DRAWING TO BUILD A HOUSE BASED ON THIS PLAN (WHETHER IN WHOLE OR IN PART) WITHOUT THE PRIOR WRITTEN CONSENT OF WILSON HOMES PTY LTD.



DIUNS	IN ANY WAY REPRODUCE, COPY, MODIFY, USE OR TAKE ADVANTAGE OF THE DRAWING TO BUILD A HOUSE BASED ON THIS PLAN (WHETHER IN WHOLE OR IN PART) WITHOUT THE PRIOR WRITTEN CONSENT OF WILSON HOMES PTY LTD.									
					luavaavav		luava- aas-		i	
SPECIFICATION:	REVISION	DRAWN	CLIENT:		HOUSE DESIGN:		HOUSE CODE:	DO NOT SCALE DRAWINGS, USE	1	
NOW BY WILSON HOMES	1 DRAFT SALE PLAN - CT1	HMI 19/08/202	WILSON COMPLETE		CYPRESS 15		H-WNWCYP10SA	FIGURED DIMENSIONS ONLY. CHECK AND VERIFY DIMENSIONS AND LEVELS PRIOR TO THE	5	
COPYRIGHT:	2 DRAFT SALE PLAN - CT1 UPDATE	HMI 20/08/202	ADDRESS:		FACADE DESIGN:			COMMENCEMENT OF ANY WORK. ALL		
© 2025	3 DRAFT SALE PLAN - UPDATED	HMI 21/08/202	14 MONTEITH CR, BAGD	DAD TAS 7030	RIVERSIDE		F-WNWCYP10RVSDA	DISCREPANCIES TO BE REPORTED TO THE DRAFTING OFFICE.	/orei	
	4 DRAFT SALE PLAN - CT1 UPDATE			COUNCIL:	SHEET TITLE:	SHEET No.:		714415	ofol	
	5 PRELIM PLANS - INITIAL ISSUE	NVO 09/09/202	46 / - / 185527	SOUTHERN MIDLANDS	LAUNDRY DETAILS	13 / 14	1:50	<i>1</i> 144 10	į	


Template Version: 24.041 File I

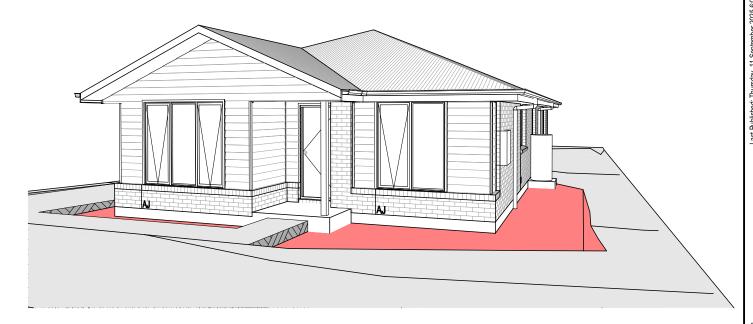

FRONT LEFT



FRONT RIGHT

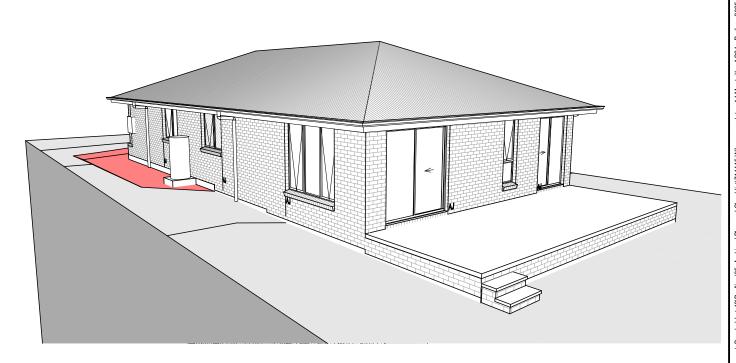

REAR LEFT

REAR RIGHT

SUBJECT TO NCC 2022 (1 MAY 2023) WATERPROOFING & PLUMBING

PLAN ACCEPTANCE BY OWNER

THIS PLAN HAS BEEN DRAWN TO REFLECT YOUR
CONSOLIDATED TENDER. PLEASE CHECK THAT EVERYTHING
IS CORRECT AND FINALISED. FURTHER STRUCTURAL
CHANGES ARE NOT POSSIBLE PAST THIS POINT.
PLEASE NOTE, SELECTIONS ITEMS WILL NOT APPEAR ON
YOUR PLANS UNTIL AFTER YOUR INTERNAL COLOUR
SELECTIONS APPOINTMENT IS COMPLETE.

SIGNATURE: DATE:

SIGNATURE: DATE:

© 2025 WILSON HOMES PTY LTD (ABN 96 126 636 897). THIS DRAWING IS AN ORIGINAL ARTISTIC WORK WITHIN THE MEANING OF THE COPYRIGHT ACT 1968 (CTH). WILSON HOMES PTY LTD IS THE OWNER OF COPYRIGHT IN THIS DRAWING. YOU HEREBY AGREE AND UNDERTAKE THAT YOU WILL NOT IN ANY WAY REPRODUCE, COPY, MODIFY, USE OR TAKE ADVANTAGE OF THE DRAWING TO BUILD A HOUSE BASED ON THIS PLAN (WHETHER IN WHOLE OR IN PART) WITHOUT THE PRIOR WRITTEN CONSENT OF WILSON HOMES PTY LTD.

N	OW
	by Wilson Homes

SPECIFICATION:		REVISION
NOW BY WILSON HOMES		DRAFT SALE PLAN - CT1
COPYRIGHT:	2	DRAFT SALE PLAN - CT1 UPDATE
© 2025		DRAFT SALE PLAN - UPDATED
	4	DRAFT SALE PLAN - CT1 UPDATE


	REVISION		RAWN	CLIENT:
1	DRAFT SALE PLAN - CT1	НМІ	19/08/2025	WILSON COM
2	DRAFT SALE PLAN - CT1 UPDATE	НМІ	20/08/2025	ADDRESS:
3	DRAFT SALE PLAN - UPDATED	НМІ	21/08/2025	14 MONTEITH
4	DRAFT SALE PLAN - CT1 UPDATE	НМІ	26/08/2025	LOT / SECTION / CT:
5	PRELIM PLANS - INITIAL ISSUE	NVO	09/09/2025	46 / - / 185527


2025	WILSON COMPLETE						
2025	ADDRESS:						
2025	14 MONTEITH CR, BAGDAD TAS 7030						
		COUNCIL:					
2025	46 / - / 185527	SOUTHERN MIDLANDS					

HOUSE DESIGN:		HOUSE CODE:
CYPRESS 15		H-WNWCY
FACADE DESIGN:		FACADE CODE:
RIVERSIDE		F-WNWCY
SHEET TITLE:	SHEET No.:	SCALES:
3D VIEWS	14 / 14	

	DO NOT SCALE DRAWINGS, USE
V/D4004	FIGURED DIMENSIONS ONLY. CHEC
YP10SA	AND VERIFY DIMENSIONS AND
	LEVELS PRIOR TO THE
<u>:</u>	COMMENCEMENT OF ANY WORK. A
VD40DVCDA	DISCREPANCIES TO BE REPORTED
YP10RVSDA	TO THE DRAFTING OFFICE.

714415

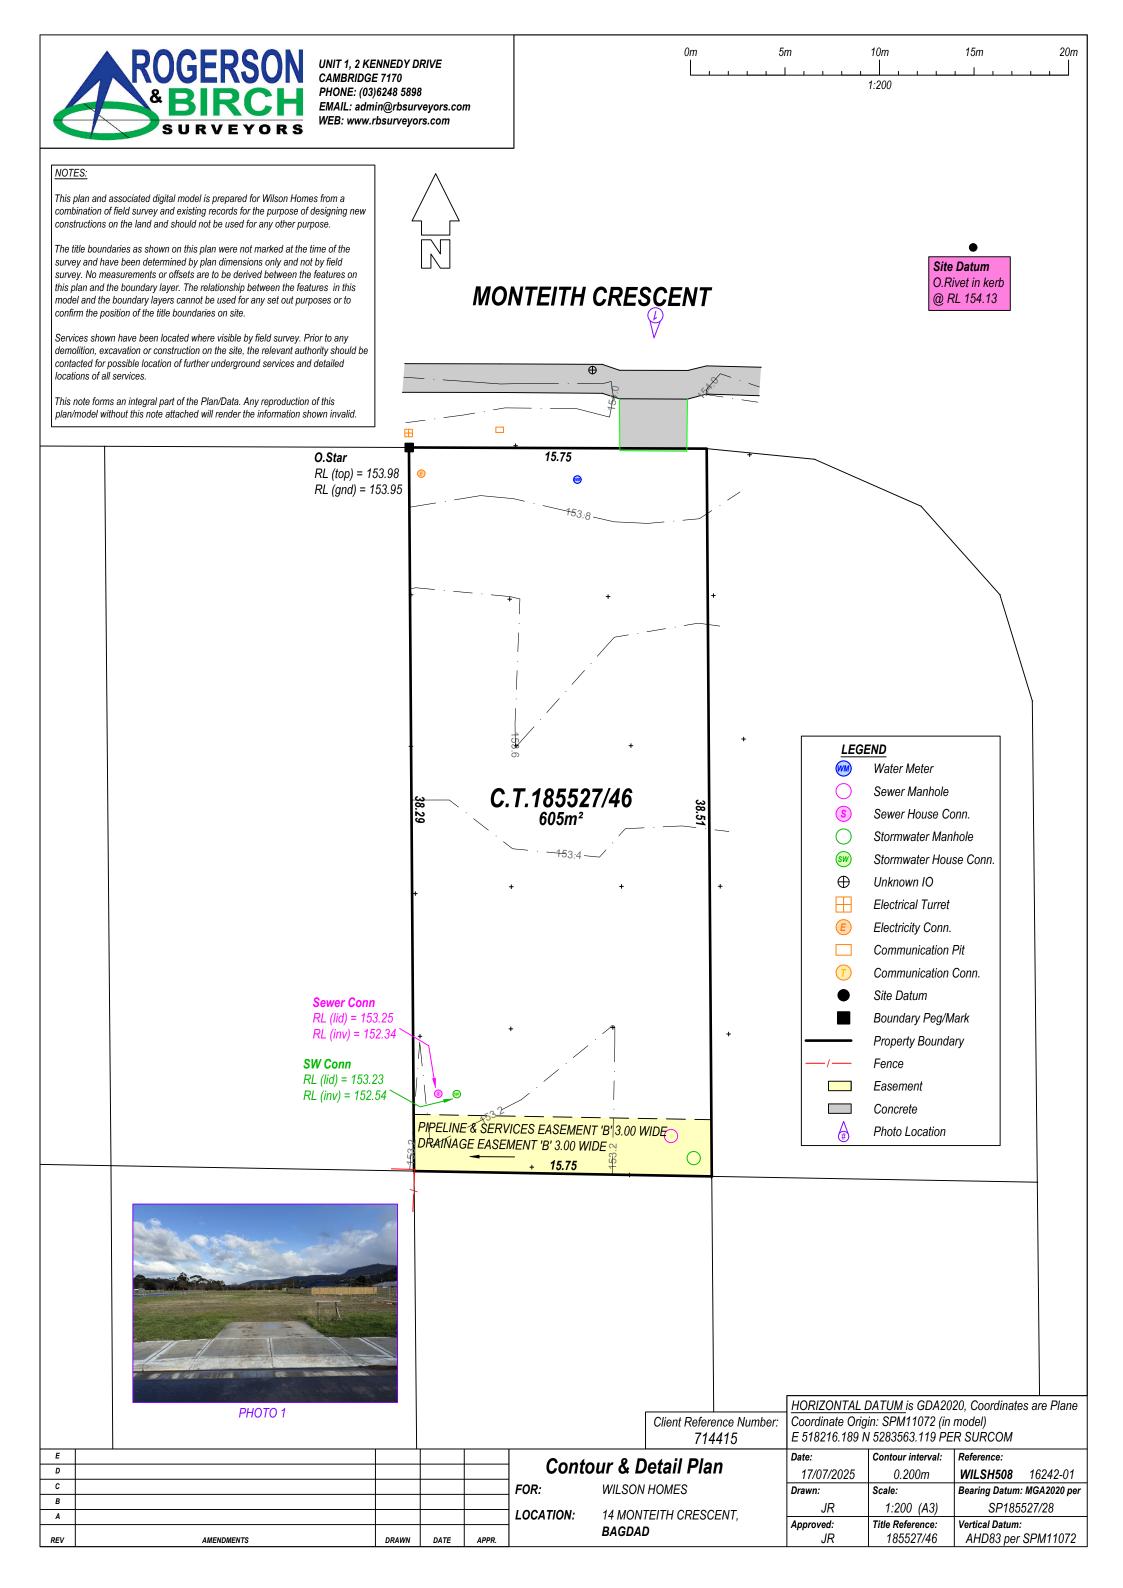

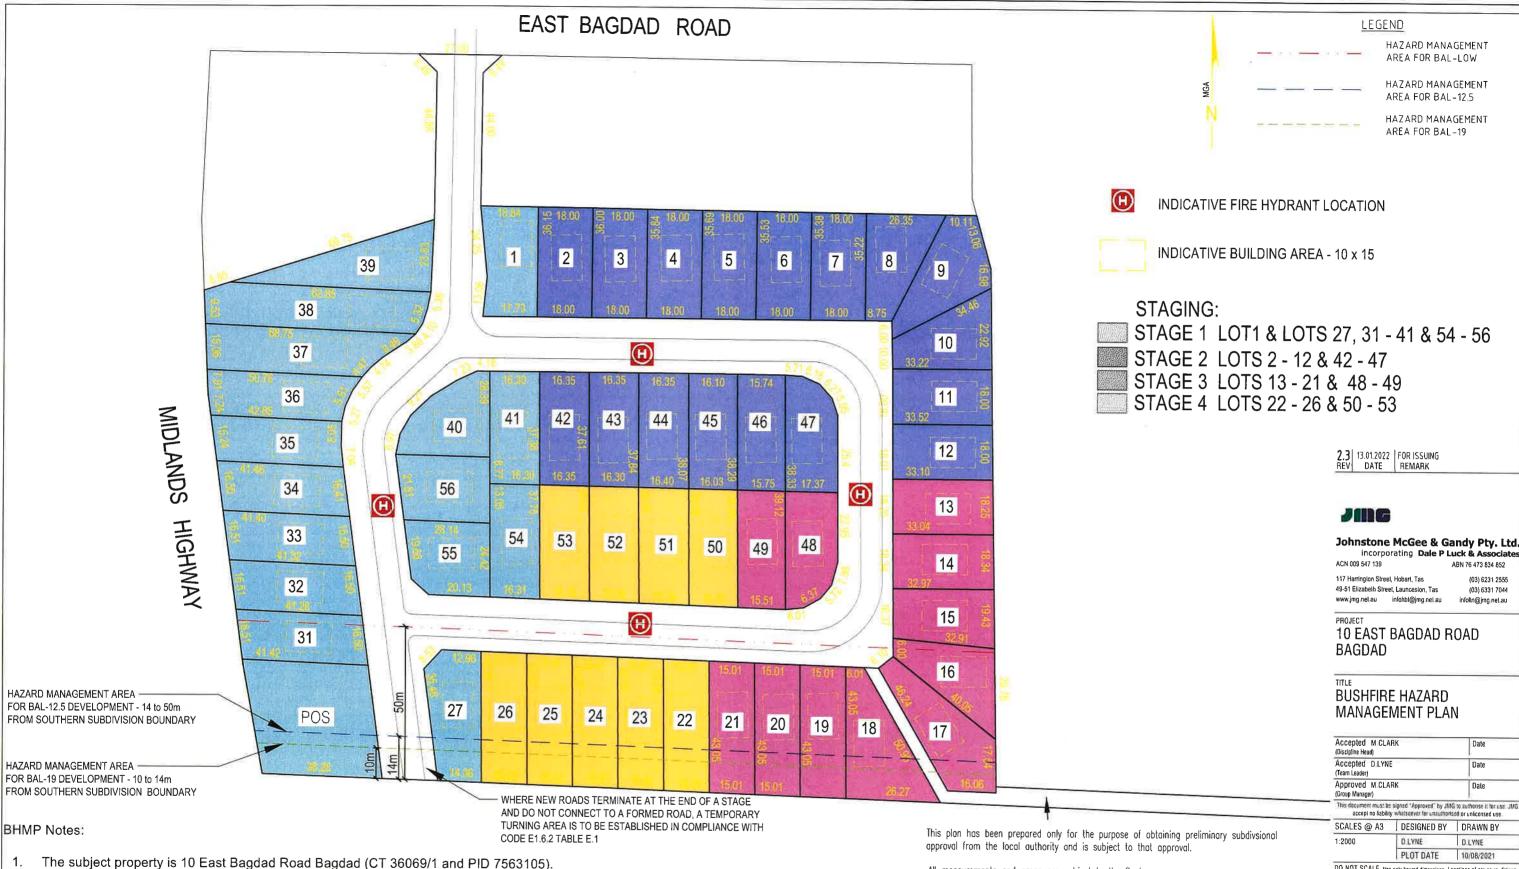

2. This plan has been prepared by Bushfire Hazard Practitioner, David Lyne (BFP-144, scope 1,2 and 3a) for certification Rhys Menadue (BFP-106, scope 1, 2, 3a, 3b, 3c).

- This plan demonstrates compliance with Code E1.0 Bushfire Prone Areas Code (BPAC) in the Southern Midlands Interim Planning Scheme 2015.
- The Hazard Management Areas (HMA) indicated on this plan must be established and maintained as per the plan and setback distances. All lots throughout the subdivision comprise the Hazard Management Areas (HMA) & must be maintained to a Low Threat Level in accordance with AS3959-2018.
- Property access arrangements must comply with Code E1.6.2 Table E1 and Table E2 of the Southern Midlands Interim Planning Scheme 2015. For design and compliance specifications reger to sections 4& 5 of the Bushfire Hazard Management Plan Report -Subdivision - 10 East Bagdad Road, Bagdad for DFY Investment Pty Ltd dated September 2021.
- 6. Fire fighting water supply complies with AS3959 and Code E1.6.3 Table E4 of the Southern Midlands Interim Planning Scheme 2015.

All measurements and areas are subject to the final survey. Base survey by Leary & Cox Surveyors - 12213 dated 2 June 2021 Base data from the LIST (www.thelist.tas.gov.au), © State of Tasmania

HAZARD MANAGEMENT AREA FOR BAL -19

Johnstone McGee & Gandy Pty. Ltd.

(03) 6331 7044 infolln@imq.net.au

Date
Date
Date

accept no liability whatsoever for unauthorised or unlicensed us

SUALES @ A3	I DESIGNED BY	I DRAWN BY
1:2000	DLYNE	D.LYNE
	PLOT DATE	10/08/2021
DO HOT DOALS		

DO NOT SCALE, Use only figured dimensions. Locations of structure, fitting DO NOT SOALE: use only figured dimensions. Locations of structure, fittings, services et or nibs drawing are indicative only. CONTRACTOR to check Architects & other project drawings for co-ordination between structure, tabric, listings, littings, services etc. CONTRACTOR to site check all dimensions and exact locations of all items. JMG accepts no responsibility for dimensional information scaled or digitally derived from this document.

PLOT DETAILS BHMP DWG

J213045PH

DWG NO.

B01

Copyright © All rights reserved. This drawing and its intellectual content remains the intellectual property of JOHNSTONE McGEE & GANDY PTY LTD (JMG) The recipient client is licensed to use this drawing for its commissioned purpose subject to authorisation per note above. Unificated use is prohibited Unificated parties may not copy, reproduce or retrainsmit or amend this document or any par of this document without JMG's prior written permission. Amendment of this document is prohibited by any party other than JMG. JMG reserve the right to revoke the licentee for use of this document.

AS2870:2011 SITE ASSESSMENT

14 Monteith Crescent Bagdad July 2025

Wilson Homes Reference: 714415



Disclaimer: The author does not warrant the information contained in this document is free from errors or omissions. The author shall not in any way be liable for any loss, damage or injury suffered by the User consequent upon, or incidental to, the existence of errors in the information.



Investigation Details

Client: Wilson Homes- Multi Res Division

Site Address: 14 Monteith Crescent, Bagdad

Date of Inspection: 16/07/2025

Proposed Works: New house

Investigation Method: Geoprobe 540UD - Direct Push

Inspected by: C. Cooper

Site Details

Certificate of Title (CT): 185527/46

Title Area: Approx. 591.6 m²

Applicable Planning Overlays: No planning scheme overlays identified

Slope & Aspect: 1° S facing slope

Vegetation: Grass & Weeds

Background Information

Geology Map: MRT

Geological Unit: Quaternary Sediments

Climate: Annual rainfall 450mm

Water Connection: Mains

Sewer Connection: Serviced-Mains

Testing and Classification: AS2870:2011, AS1726:2017 & AS4055:2021



Investigation

A number of bore holes were completed to identify the distribution and variation of the soil materials at the site, bore hole locations are indicated on the site plan. See soil profile conditions presented below. Tests were conducted across the site to obtain bearing capacities of the material at the time of this investigation.

Soil Profile Summary

BH 1 Depth (m)	BH 2 Depth (m)	uscs	Description
0.00-0.20	0.00-0.20	SM	Silty SAND : dark grey, brown, slightly moist, medium dense
0.20-0.90	0.20-0.60	СН	Silty CLAY : high plasticity, grey, brown, slightly moist, stiff
0.90-2.20	0.60-2.00	CL	Sandy CLAY: medium plasticity, brown, slightly moist, stiff, refusal on cemented material

Site Notes

Soils on the site are developing from quaternary sediments, the clay fraction is likely to show moderate ground surface movement with moisture fluctuations.

Site Classification

The site has been assessed and classified in accordance with AS2870:2011 "Residential Slabs and Footings".

The site has been classified as:

Class M

*y*_s range: **20-40mm**

Notes: that is a moderately reactive clay.



Wind Loading Classification

According to "AS4055:2021 - Wind Loads for Housing" the house site is classified below:

١	Wind Classification:	N2
	Region:	Α
	Terrain Category:	2.5
	Shielding Classification:	PS
	Topographic Classification:	T0
	Wind Classification:	N2
	Design Wind Gust Speed – m/s (V _{h,u}):	40

Construction Notes & Recommendations

The site has been classified as **Class M** - Moderately reactive clay or silt site, which may experience moderate ground movement from moisture changes.

It is recommended that all footings be founded in the natural material with bearing capacities >100kPa.

All earthworks on site must comply with AS3798:2007, and I further recommend that consideration be given to drainage and sediment control on site during and after construction. Care should also be taken to ensure there is adequate drainage in the construction area to avoid the potential for weak bearing and foundation settlement associated with excessive soil moisture.

I also recommend that during construction that I and/or the design engineer be notified of any major variation to the foundation conditions as predicted in this report.

Dr John Paul Cumming B.Agr.Sc (hons) PhD CPSS GAICD

Director



Explanatory Notes

1 Scope of Works

The methods of description and classification of soils used in this report are based largely on Australian Standard 1726 – Geotechnical Site Investigations (AS1726:2017), with reference to Australian Standard 1289 – Methods for testing soils for engineering purposes (AS1289), for eventual Site Classification according to Australian Standard 2870 (AS2870:2011) – Residential Slabs and Footings and Australian Standard 1547 (AS1547:2012) On-site domestic wastewater management.

1.1 Site Classification AS2870:2011

Site classification with reference to the above Australian Standards are based on site reactivity.

Class	Foundation Conditions	Characteristic Surface Movement
Α	Most sand and rock sites with little or no ground movement from moisture changes.	0mm
S	Slightly reactive clay sites, which may experience only slight ground movement from moisture changes.	0 – 20mm
М	Moderately reactive clay or silt sites, which may experience moderate ground movement from moisture changes.	20 – 40mm
H-1	Highly reactive clay sites, which may experience high ground movement from moisture changes.	40 – 60mm
H-2	Highly reactive clay sites, which may experience very high ground movement from moisture changes.	60 – 75mm
E	Extremely reactive sites, which may experience extreme ground movement from moisture changes.	>75mm

Note: Soils where foundation performance may be significantly affected by factors other than reactive soil movement are classified as **Class P**.

A site is classified as Class P when:

- The bearing capacity of the soil profile in the foundation zone is generally less than 100kpa
- If excessive foundation settlement may occur due to loading on the foundation.
- The site contains uncontrolled fill greater than 0.8m in depth for sandy sites and 0.4m in depth for other soil materials.
- The site is subject to mine subsistence, landslip, collapse activity or coastal erosion.
- The site is underlain by highly dispersive soils with significant potential forerosion
- If the site is subject to abnormal moisture conditions which can affect foundation performance



1.2 Soil Characterisation

This information explains the terms of phrase used within the soil description area of the report.

It includes terminology for cohesive and non-cohesive soils and includes information on how the Unified Soil Classification Scheme (USCS) codes are determined.

NON COHSIVE - SAND & GRAVEL							
Consistency Description	Dynamic Cone Penetrometer blows/100 mm						
Very loose (VL)	Easily penetrated with 13 mm reinforcing rod pushed by hand.	0 - 1					
Loose (L)	Easily penetrated with 13 mm reinforcing rod pushed by hand. Can be excavated with a spade; 50 mm wooden peg can be easily driven.	1 - 3					
Medium dense (MD)	Penetrated 300 mm with 13 mm reinforcing rod driven with 2 kg hammer, - hard shovelling.	3 - 8					
Dense (D)	Penetrated 300 mm with 13 mm reinforcing rod driven with 2 kg hammer, requires pick for excavation: 50 mm wooden peg hard to drive.	8 - 15					
Very dense (VD)	Penetrated only 25 - 50 mm with 13 mm reinforcing rod driven with 2 kg hammer.	>15					

Consistency Description	Field Test	Indicative undrained shear strength kPa
Very soft	Easily penetrated >40 mm by thumb. Exudes between thumb and fingers when squeezed in hand.	<12
Soft	Easily penetrated 10 mm by thumb. Moulded by light finger pressure	>12 and <25
Firm	Impression by thumb with moderate effort. Moulded by strong finger pressure	>25 and <50
Stiff	Slight impression by thumb cannot be moulded with finger.	>50 and <100
	Very tough. Readily indented by thumbnail.	
Very Stiff		>100 and <200
	Brittle. Indented with difficulty by thumbnail.	
Hard		>200



1.3 USCS Material Descriptions

Soils for engineering purposes are the unconsolidated materials above bedrock, they can be residual, alluvial, colluvial or aeolian in origin.

Major Divisions		Particle size mm	USCS Group Symbol	Typical Names			Labo	ratory Cla	essification	7.23	
128	BOULDERS	200			%<	0.075 mm (2)	Plasticity of fine fraction	$C_{ii} = \frac{D_{i0}}{D_{ii}}$	$C_i = \frac{(D_{sc})^i}{(D_{sc})(D_{sc}}$	NOTES	
(ma	COBBLES	200									
S larger than 0.075 mm)		63	GW	Well graded gravels and gravel-sand mixtures, little or no fines		0-5	-	>4	Between 1 and 3	(1) Identify fines by the method given	
R larger t	GRAVELS (more than	coarse	GP	Poorly graded gravels and gravel-sand mixtures, little or no fines, uniform gravels	'Wajor Divisions'	0-5	=		comply with	for fine-grained soils.	
NED SO	half of coarse	medium	GM	Silty gravels, gravel-sand-silt mixtures (1)	Wajor [12-50	Below 'A' line or PI<4		-		
COARSE GRAINED SOILS derial less than 63 mm is la	fraction is larger than 2.36 mm)	6 fine 2.36	GC	Clayey gravels, gravel-sand- clay mixtures (1)	n gven in	12-50	Above 'A' line and PI>7	1	-	(2) Borderline	
8	SANDS		sw	Well graded sands and gravelly sands, little or no fines	he catteda	0-5		>6	Between 1 and 3	classifications occur when the percentage of fines (fraction	
Stan half of	(more than half of coarse fraction is	nalf of0.6 coarse raction is medium	SP	Poorly graded sands and gravelly sands, little or no fines	according to the	0-5 — Fails to con		comply with	smaller than 0.075 mm size) is greater than		
(more \$1			SM	Silty sands, sand silt mixtures (1)	INS BOCO	12-50	Below 'A' line or PI<4	-		5% and less than 12%. Borderline classifications require the use of SP-SM, GW- GC.	
-			SC	Clayey sands, sand-clay mixtures (1)	of fractions	12-50	Above 'A' line and PI>7	_	-		
man 0.075 mm			ML	Inorganic silts, very fine sands, rock flour, silty or clayey fine sands or clayey silts with slight plasticity	dassification			classificati	ticity Cha	ined soils	
smaller	SILTS & CLA (Liquid Limit	3550	CL CI	Inorganic clays of low to medium plasticity, gravelly clays, sandy clays, silty clays, lean clays	3 63 mm for	80			n of coarse gr	rained soils.	
SOILS			OL	Organic silts and clays of low plasticity	passin					130	
E GRANED SOILS less than 63 mm &			МН	Inorganic silts, mic- aceous or diato-maceous fine sands or silts, elastic silts	curve of material passing Plastic Index (%)	s s				This the things	
FINE ledal le	SILTS & CLA (Liquid Limit	100000000	or sifts, elastic sifts CH Inorganic clays of high plasticity, fat clays		MILE	96					
(more than half of mate			ОН	Organic silts and clays of high plasticity	adation	30 0	Zen	"	401		
	HIGHLY OR	GANIC	PT	Peat and other highly organic soils	Use the gradation		10 20	so 40 Liqu	se es aid Limit (%)	70 M2 96 100	



Grain size analysis is performed by two processes depending on particle size. Sand silt and clay particles are assessed using a standardised hydrometer test, and coarse sand and larger is assessed through sieving by USCS certified sieves. For more detail see the following section.

Soil Classification	Particle Size
Clay	Less than 0.002mm
Silt	0.002 – 0.06mm
Fine/Medium Sand	0.06 – 2.0mm
Coarse Sand	2.0mm – 4.75mm
Gravel	4.75mm – 60.00mm

1.4 Bearing Capacities and DCP testing.


DCP and PSP weighted penetrometer tests – Dynamic Cone Penetrometer (DCP) and Perth Sand Penetrometer (PSP) tests are carried out by driving a rod into the ground with a falling weight hammer and measuring the blows for successive 100mm increments of penetration. Normally, there is a depth limitation of 1.2m but this may be extended in certain conditions by the use of extension rods. The methods for the two tests are quite similar.

- Dynamic Cone Penetrometer a 16mm rod with a 20mm diameter cone end is driven with a 9kg hammer dropping 510mm (AS 1289, Test 6.3.2).
- Perth Sand Penetrometer a 16mm diameter flat-ended rod is driven with a 9kg hammer, dropping 600mm (AS 1289 Test 6.3.3). This test was developed for testing the density of sands and is mainly used in granular soils and filling.

Site Anomalies – During construction GES will need to be notified of any major variation to the foundation conditions as predicted in this report.



1.5 Batter Angles for Embankments (Guide Only)

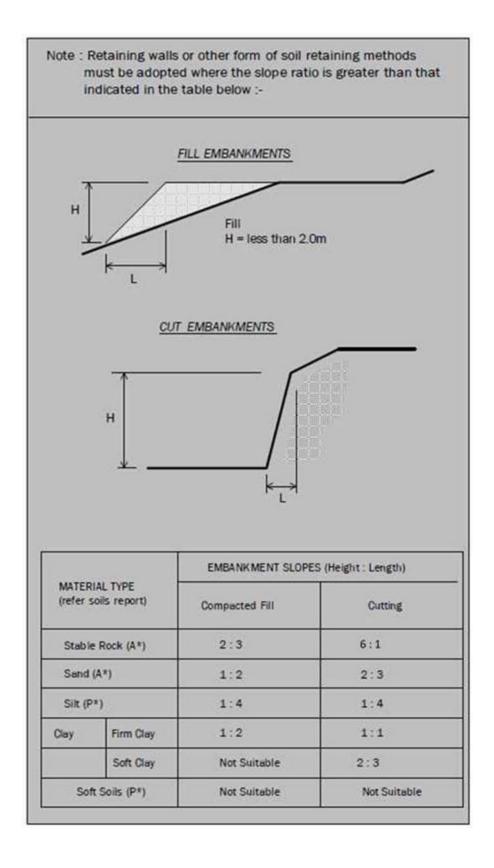



Glossary of Terms

Bearing Capacity – Maximum bearing pressure that can be sustained by the foundation from the proposed footing system under service loads which should avoid failure or excessive settlement.

Clay – (Mineral particles less than 0.002mm in diameter). Fine grained cohesive soil with plastic properties when wet. Also includes sandy clays, silty clays, and gravelly clays.

Dynamic Cone Penetrometer (DCP) – Field equipment used to determine underlying soil strength and therefore bearing capacity (kPa) by measuring the penetration of the device into the soil after each hammer blow.

Dispersive soil – A soil that has the ability to pass rapidly into suspension in water.

Footing – Construction which transfers the load from the building to the foundation.

Foundation – Ground which supports the building

Landslip – Foundation condition on a sloping site where downhill foundation movement or failure is a design consideration.

Qualified Engineer – A professional engineer with academic qualifications in geotechnical or structural engineering who also has extensive experience in the design of the footing systems for houses or similar structures.

Reactive Site – Site consisting of clay soil which swells on wetting and shrinks on drying by an amount that can damage buildings on light strip footings or unstiffened slabs. Includes sites classified as S, M, H-1, H-2 & E in accordance with AS2870-2011.

Sand – (Mineral particles greater than 0.02mm in diameter). Granular non-cohesive, non-plastic soil that may contain fines including silt or clay up to 15%.

Services – Means all underground services to the site including but not limited to power, telephone, sewerage, water & storm water.

Silt – (Mineral particles 0.002 - 0.02mm in diameter). Fine grained non-cohesive soil, non-plastic when wet. Often confers a silky smoothness of field texture, regularly includes clay and sand to form clayey silts, sandy silts and gravelly silts.

Site – The site title, as denoted by address, lot number, or Certificate of Title (CT) number, or Property Identification Number (PID).

Surface Movement (Ys) – Design movement (mm) at the surface of a reactive site caused by moisture changes.



Disclaimer

This Report has been prepared in accordance with the scope of services between Geo-Environmental Solutions Pty. Ltd. (GES) and the Client. To the best of GES's knowledge, the information presented herein represents the client's requirements at the time of printing of the Report. However, the passage of time, manifestation of latent conditions or impacts of future events may result in findings differing from that discussed in this Report. In preparing this Report, GES has relied upon data, surveys, analyses, designs, plans and other information provided by the Client and other individuals and organisations referenced herein. Except as otherwise stated in this Report, GES has not verified the accuracy or completeness of such data, surveys, analyses, designs, plans and other information.

The scope of this study does not allow for the review of every possible geotechnical parameter or the soil conditions over the whole area of the site. Soil and rock samples collected from the investigation area are assumed to be representative of the areas from where they were collected and not indicative of the entire site. The conclusions discussed within this report are based on observations and/or testing at these investigation points.

This report does not purport to provide legal advice. Readers of the report should engage professional legal practitioners for this purpose as required.

No responsibility is accepted for use of any part of this report in any other context or for any other purpose by a third party.







Site Plan







APPENDIX 1 - DCP Results Table

Dynamic Cone Penetration (DCP) Conversion to Californian Bearing Ratio (ref: Australian Standard AS 1289.6.3.2 - 1997)

DCP Location BH1

Depth (mm)	DCP	DCP	DCP Resistance	Allowable Bearing Capacity	CBR (Rounded Up)
	(Blows/100mm)	(mm/Blow)	(mPa)	(kPa)	
0-100	5	20.0	1.6	174	10
100-200	10	10.0	3.1	347	22
200-300	12	8.3	3.8	417	27
300-400	11	9.1	3.4	382	25
400-500	8	12.5	2.5	278	17
500-600	11	9.1	3.4	382	25
600-700	10	10.0	3.1	347	22
700-800	11	9.1	3.4	382	25
800-900	12	8.3	3.8	417	27
900-1000	11	9.1	3.4	382	25
1000-1100	11	9.1	3.4	382	25
1100-1200	15	6.7	4.7	521	35
1200-1300	15	6.7	4.7	521	35



Appendix 2 – Site Photos





CERTIFICATE OF QUALIFIED PERSON – ASSESSABLE ITEM

Section 321

To:	Wilson Homes- Multi Res Division			Owner /Agent		E E	
	250 Murray Street			Address	Form	55	
	Hobart	70	00	Suburb/postcode			
Qualified perso	on details:						
Qualified person:	John-Paul Cumming						
Address:	29 Kirksway Place			Phone No: 03 6223 1839			
	Battery Point	70	04	Fax No:			
Licence No:				@geosolutio	ns.ne	t.au	
Qualifications and Insurance details:	Certified Professional Soil Scientist (CPSS stage 2)		Directo	description from Column 3 of the Director's Determination - Certificates by Qualified Persons for Assessable tems			
Speciality area of expertise:	AS2870-2011 Foundation Classification		(description from Column 4 of the Director's Determination - Certificates by Qualified Persons for Assessable Items)				
Details of work:							
Address:	14 Monteith Crescent			Lot No:			
	Bagdad	70:	30	Certificate of	title No:	185527/4 6	
The assessable item related to this certificate:	Classification of foundation Conditions according to AS2870-2011		(description of the assessable item being certified) Assessable item includes – - a material; - a design - a form of construction - a document - testing of a component, building system or plumbing system - an inspection, or assessment, performed				
Certificate details:							
Certificate type:	School Dete		scription from Column 1 of nedule 1 of the Director's ermination - Certificates by alified Persons for nessable Items n)				
This certificate is in relation to the above assessable item, at any stage, as part of - (tick one) building work, plumbing work or plumbing installation or demolition work							
or a building, temporary structure or plumbing installation: □							

In issuing this certificate the following matters are relevant -

Documents: The attached soil report for the address detailed above in 'details of

work'

Relevant

calculations: Reference the above report.

References: AS2870:2011 residential slabs and footings

AS1726:2017 Geotechnical site investigations

CSIRO Building technology file - 18.

Substance of Certificate: (what it is that is being certified)

Site Classification consistent with AS2870-2011.

Scope and/or Limitations

The classification applies to the site as inspected and does not account for future alteration to foundation conditions as a result of earth works, drainage condition changes or variations in site maintenance.

I, John-Paul Cumming certify the matters described in this certificate.

Qualified person:

Signed:

Certificate No:

J11918 :

22/07/2025


Date:

John Paul Cumming



RESULT OF SEARCH

RECORDER OF TITLES

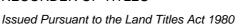



SEARCH OF TORRENS TITLE

VOLUME 185527	FOLIO 46
EDITION	DATE OF ISSUE
2	18-Mar-2025

SEARCH DATE : 04-Jul-2025 SEARCH TIME : 11.30 AM

DESCRIPTION OF LAND

Parish of STRANGFORD Land District of MONMOUTH Lot 46 on Sealed Plan 185527 Derivation: Part of 60A-1R-34P Gtd. to C.A. Galletly and Anor. Prior CT 36069/1

SCHEDULE 1

N160293 TRANSFER to WILSON HOMES TASMANIA PTYLTD Registered 18-Mar-2025 at 12.01 PM

SCHEDULE 2

Reservations and conditions in the Crown Grant if any SP185527 EASEMENTS in Schedule of Easements SP185527 COVENANTS in Schedule of Easements SP185527 FENCING COVENANT in Schedule of Easements

UNREGISTERED DEALINGS AND NOTATIONS

No unregistered dealings or other notations




FOLIO PLAN

RECORDER OF TITLES



Issued Pursuant to the Land Titles Act 1980

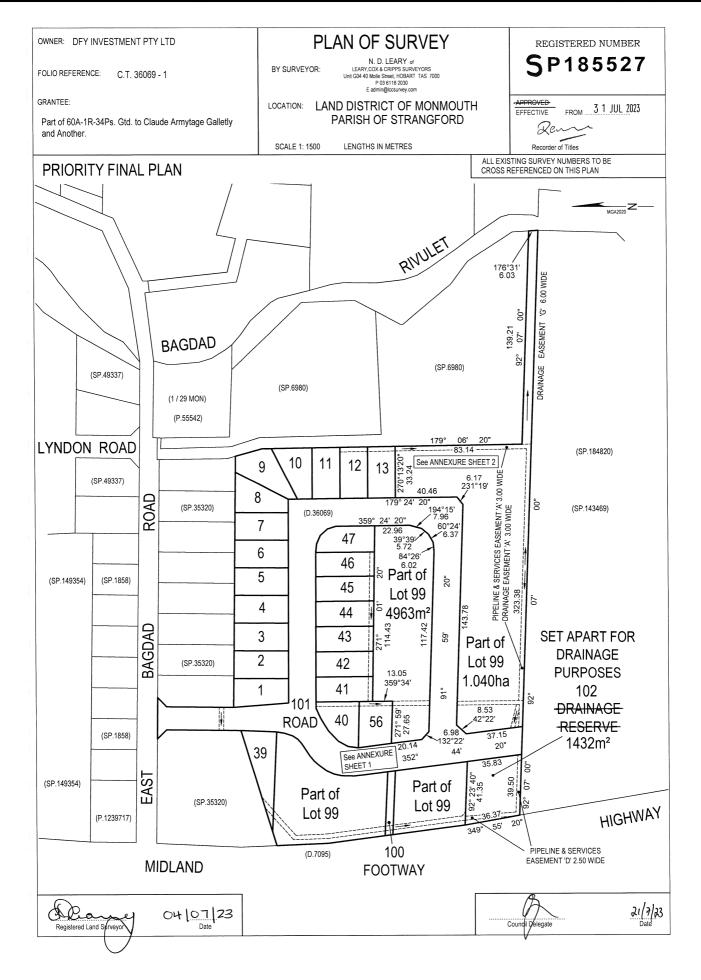




FOLIO PLAN

RECORDER OF TITLES



Issued Pursuant to the Land Titles Act 1980

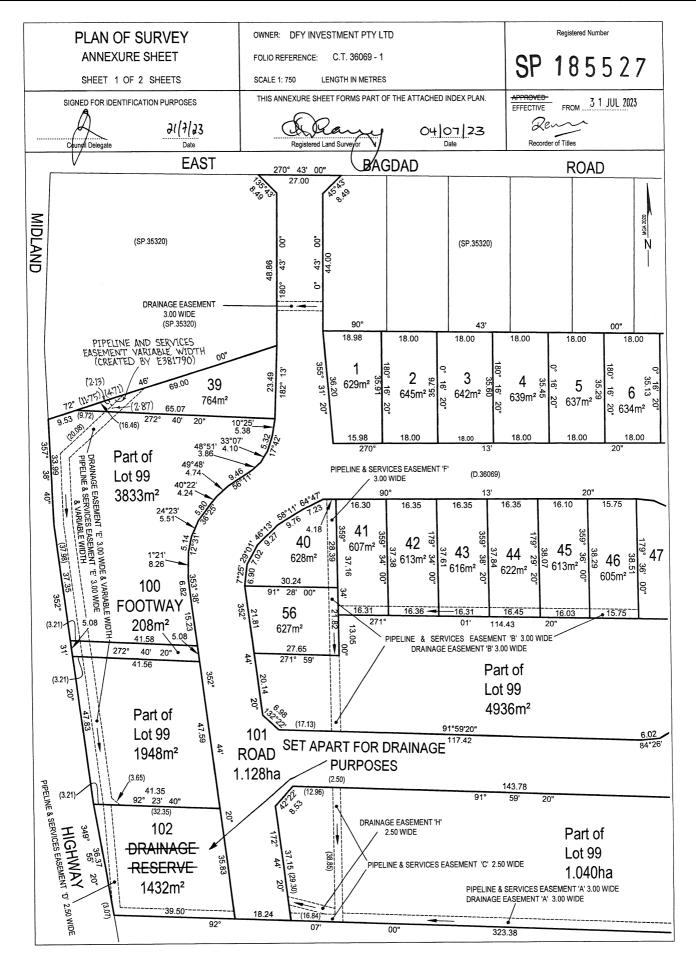




FOLIO PLAN

RECORDER OF TITLES



Issued Pursuant to the Land Titles Act 1980

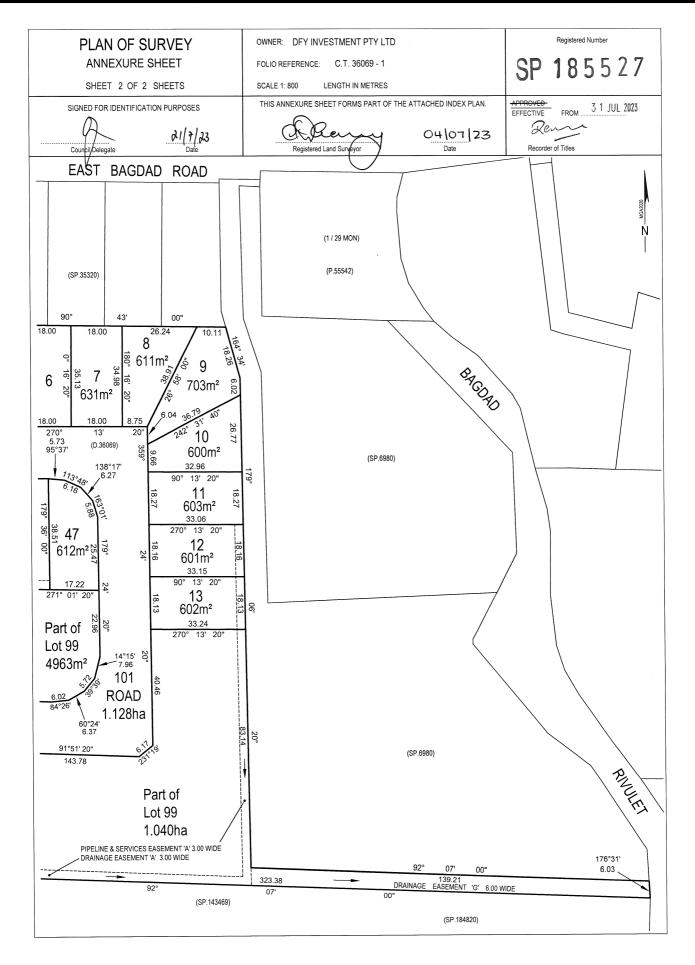

Search Date: 04 Jul 2025 Search Time: 11:30 AM Volume Number: 185527 Revision Number: 03 Page 3 of 3



RECORDER OF TITLES

Issued Pursuant to the Land Titles Act 1980



SCHEDULE OF EASEMENTS

NOTE: THE SCHEDULE MUST BE SIGNED BY THE OWNERS & MORTGAGEES OF THE LAND AFFECTED. SIGNATURES MUST BE ATTESTED.

Registered Number

SP 185527

PAGE 1 OF 6 PAGES

EASEMENTS AND PROFITS

Each lot on the plan is together with:-

- such rights of drainage over the drainage easements shown on the plan (if any) as may be necessary to drain the stormwater and other surplus water from such lot; and
- any easements or profits a prendre described hereunder.

Each lot on the plan is subject to:-

- such rights of drainage over the drainage easements shown on the plan (if any) as passing through such lot as may be necessary to drain the stormwater and other surplus water from any other lot on the plan; and
- any easements or profits a prendre described hereunder.

The direction of the flow of water through the drainage easements shown on the plan is indicated by arrows.

Easements

the Plan.

Lots 12 & 13 on the Plan are subject to a Pipeline and Service Easement in gross in favour of TasWater over the area marked "PIPELINE & SERVICES EASEMENT 'A' 3.00 WIDE" shown on the Plan.

Lots 12 & 13 on the Plan are subject to a right of drainage in gross in favour of the Southern Midlands Council over the area marked "DRAINAGE EASEMENT 'A' 3.00 WIDE" shown on the Plan. · Pipeline and Service Easement in gross in favour of TasWater Lot 39 on the Plan is subject to a right of drainage in gross in favour of the Southern Midlands Council over the area marked "DRAINAGE EASEMENT, E' 3.00 WIDE & VARIABLE WIDTH" shown on

Lot 39 on the Plan is subject to a right of drainage in gross in favour of the Southern Midlands Council over the area marked "DRAINAGE EASEMENT 'E' 3.00 WIDE," shown on the Plan.

□ "PIPELINE & SERVICES EASEMENT

& VARIABLE WIDTH"

Lot 40 on the Plan is subject to a Pipeline and Services Easement in gross in favour of TasWater over the area marked "PIPELINE & SERVICES EASEMENT 'F' 3.00 WIDE" shown on the Plan.

Lots 41-46 on the Plan are subject to a Pipeline and Services Easement in gross in favour of TasWater over the area marked "PIPELINE & SERVICES EASEMENT 'B' 3.00 WIDE" shown on the Plan.

Lots 41-46 on the Plan are subject to a right of drainage in gross in favour of the Southern Midlands Council over the area marked "DRAINAGE EASEMENT 'B' 3.00 WIDE" shown on the Plan.

LECALREPLESENTAME NADINDER * / BAPCAYUE PAMUE SINCLES 28/1/23

SUBDIVIDER: DFY INVESTMENT PTY LTD

FOLIO REF: CTs 36069/1

SOLICITOR

& REFERENCE: Abetz Curtis - 220233

PLAN SEALED BY:

NOTE: The Council Delegate must sign the Certificate for the purposes of identification.

Page 1 of 6 Search Time: 11:30 AM Revision Number: 03 Search Date: 04 Jul 2025 Volume Number: 185527

Coundil Delegate



RECORDER OF TITLES

Issued Pursuant to the Land Titles Act 1980



ANNEXURE TO SCHEDULE OF EASEMENTS

PAGE 2 OF 6 PAGES

Registered Number

SP. 185527

SUBDIVIDER: DFY INVESTMENT PTY LTD

FOLIO REFERENCE: C/T 36069/1

Lot 56 on the Plan is subject to a Pipeline and Services Easement in gross in favour of TasWater over the area marked "PIPELINE & SERVICES EASEMENT 'B' 3.00 WIDE" shown on the Plan.

Lot 56 on the Plan is subject to a right of drainage in gross in favour of the Southern Midlands Council over the area marked "DRAINAGE EASEMENT 'B' 3.00 WIDE" shown on the Plan.

Lot 99 on the Plan is subject to a Pipeline and Services Easement in gross in favour of TasWater over the area marked "PIPELINE & SERVICES EASEMENT 'B' 3.00 WIDE" shown on the Plan.

Lot 99 on the Plan is subject to a right of drainage in gross in favour of the Southern Midlands Council over the area marked "DRAINAGE EASEMENT 'B' 3.00 WIDE" shown on the Plan.

Lot 99 on the Plan is subject to a right of drainage in gross in favour of the Southern Midlands Council over the area marked "DRAINAGE EASEMENT 'H' 2.50 WIDE" shown on the Plan.

Lot 99 on the Plan is subject to a Pipeline and Services Easements in gross in favour of Taswater over the area marked "PIPELINE & SERVICES EASEMENT 'C' 2.50 WIDE" shown on the Plan.

Lot 99 on the Plan is subject to a Pipeline and Services Easements in gross in favour of TasWater over the area marked "PIPELINE & SERVICES EASEMENT 'A' 3.00 WIDE" shown on the Plan.

Lot 99 on the Plan is subject to a right of drainage in gross in favour of the Southern Midlands Council over the area marked "DRAINAGE EASEMENT 'A' 3.00 WIDE" shown on the Plan.

Lot 99 on the Plan is subject to a right of drainage in gross in favour of the Southern Midlands Council over the area marked "DRAINAGE EASEMENT 'E' 3.00 WIDE & VARIABLE WIDTH" shown on the Plan.

Lot 99 on the Plan is subject to Pipeline and Services Easements in gross in favour of TasWater over the area marked "PIPELINE & SERVICES EASEMENT 'E' 3.00 WIDE, shown on the Plan. ANILVAMUE

& VARIABLE WIDTH"

Lot 99 on the Plan is subject to a right of drainage in gross in favour of the Southern Midlands Council over the area marked "DRAINAGE EASEMENT 'G' 6.00 WIDE" shown on the Plan.

Lot 100 on the Plan is subject to a right of drainage in gross in favour of the Southern Midlands Council over the area marked "DRAINAGE EASEMENT 'E' 3.00 WIDE & VARIABLE WIDTH" shown on the Plan.

NOTE: Every annexed sheet must be signed by the parties to the dealing or where the party is a corporate body be signed by the persons who have attested the affixing of the seal of that body to the dealing.

Page 2 of 6 Revision Number: 03 Search Date: 04 Jul 2025 Search Time: 11:30 AM Volume Number: 185527

UEUAL NUMESON SUPPINDE



RECORDER OF TITLES

Issued Pursuant to the Land Titles Act 1980



ANNEXURE TO SCHEDULE OF EASEMENTS

PAGE 3 OF 6 PAGES

Registered Number

SP 185527

SUBDIVIDER: DFY INVESTMENT PTY LTD

FOLIO REFERENCE: C/T 36069/1

* & VARIABLE WIDTH"

Lot 100 on the Plan is subject to Pipeline and Services Easements in gross in favour of TasWater over the area marked "PIPELINE & SERVICES EASEMENT 'E' 3.00 WIDE" shown on the Plan.

(appurtenant to Lots 2 to 9 on Sealed Plan 35320) &

Lot 101 on the Plan is subject to a right of drainage in gross in favour of the Southern Midlands Council over the area marked "DRAINAGE EASEMENT 3.00 WIDE (SP 35320)" shown on the Plan.

Lot 102 on the Plan is subject to a right of drainage in gross in favour of the Southern Midlands Council over the area marked "DRAINAGE EASEMENT 'E' 3.00 WIDE & VARIABLE WIDTH" shown on the Plan.

Lot 102 is subject to a right of Pipeline and Services Easement in favour of TasWater over the area marked "PIPELINE & SERVICES EASEMENT 'E', 3.00 WIDE" shown on the Plan.

'D' 2.50 *

Restrictive Covenants

The owner of each lot on the Plan covenants with the Vendor DFY INVESTMENT PTY LTD and the owners for the time being of every other lot shown on the plan to the extent that the burden of these covenants may run with and bind the Covenantor's lot and every part thereof and the benefit thereof shall be annexed to and devolve with each and every part of every other lot shown on the said Plan to observe the following stipulations:

- 1. Not to erect any building on any such lot with outer walls of asbestos cement sheeting.
- Not without prior written consent from the Vendor construct any walls of any building on any such
 lot from any material except, brick, stone, masonry block, or similar material, rendered insulated
 concrete forms, timber construction, flat metal cladding or insulated boards that are rendered,
 painted or pre-coloured.
- 3. Not to erect a dwelling on any such lot without a minimum of one (1) single garage under the roof of the dwelling.
- 4. Not to erect any dwelling house or residential building on a such lot using any roofing material or with roofs other than tiles or colourbond iron.
- 5. Not to erect any garage or outbuilding on any such lot using any roofing material or with roofs other than tiles or colourbond iron.
- 6. Not without prior written consent from the Vendor construct or allow to be constructed any kit home or relocatable dwelling on any such lot.

NOTE: Every annexed sheet must be signed by the parties to the dealing or where the party is a corporate body be signed by the persons who have attested the affixing of the seal of that body to the dealing.

28/7/23
4/7/23
(2)
4/7/23
4/7/23
4/7/23
4/7/23
4/7/23
4/7/23
4/7/23
4/7/23

Page 3 of 6



RECORDER OF TITLES

Issued Pursuant to the Land Titles Act 1980



ANNEXURE TO SCHEDULE OF EASEMENTS

PAGE 4 OF 6 PAGES

Registered Number

SP 185527

SUBDIVIDER: DFY INVESTMENT PTY LTD

FOLIO REFERENCE: C/T 36069/1

- 7. Not to erect or place or suffer to be or remain on any such lot any temporary building structure or caravan, except a shed or workshop that is used for the purpose of and in connection with, and during the construction of a permanent building or buildings on any such lot and not otherwise.
- 8. Not to erect on any such lot any buildings other than one private dwelling house and the usual outbuildings appurtenant thereto.
- 9. The main building erected on any portion of any such lot shall not be used for any other purpose than a private residential house.
- 10. Not to erect or permit to be erected or remain on any such lot any hoarding or advertising sign (except any notice or advertisement in the usual format for the sale or letting of any such lot or any building erected thereon).
- 11. Not to erect on any such lot any residential buildings of a size less than 125m2 (including an attached garage).
- 12. Not to erect a fence on any such lot in any material other than timber paling or colourbond iron or metal in the colour 'Monument'.

Interpretation

"Pipeline and Services Easement" is defined as follows: -

FIRSTLY, THE FULL AND FREE RIGHT AND LIBERTY for TasWater and its employees, contractors, agents and all other persons duly authorised by it, at all times to:

- (1) enter and remain upon the Easement Land with or without machinery, vehicles, plant and equipment;
- (2) investigate, take soil, rock and other samples, survey, open and break up and excavate the Easement Land for any purpose or activity that TasWater is authorised to do or undertake;
- (3) install, retain, operate, modify, relocate, maintain, inspect, cleanse, repair, remove and replace the Infrastructure;
- (4) run and pass sewage, water and electricity through and along the Infrastructure;

(5) do all works reasonably required in connection with such activities or as may be authorised or required by any law:

NOTE: Every annexed sheet must be signed by the parties to the dealing or where the party is a corporate body be signed by the persons who have attested the affixing of the seal of that body to the dealing.

Search Date: 04 Jul 2025 Search Time: 11:30 AM Volume Number: 185527 Revision Number: 03 Page 4 of 6



RECORDER OF TITLES

Issued Pursuant to the Land Titles Act 1980



ANNEXURE TO SCHEDULE OF EASEMENTS

PAGE 5 OF 6 PAGES

Registered Number

SP 185527

SUBDIVIDER: DFY INVESTMENT PTY LTD

FOLIO REFERENCE: C/T 36069/1

- (a) without doing unnecessary damage to the Easement Land; and
- (b) leaving the Easement Land in a clean and tidy condition;
- (6) if the Easement Land is not directly accessible from a highway, then for the purpose of undertaking any of the preceding activities TasWater may with or without employees, contractors, agents and any other persons authorised by it, and with or without machinery, vehicles, plant and equipment enter the Lot from the highway at any vehicle entry and cross the Lot to the Easement Land; and
- (7) use the Easement Land as a right of carriageway for the purpose of undertaking any of the preceding purposes on other land, TasWater reinstating any damage that it causes in doing so to any boundary fence of the Lot.

SECONDLY, the benefit of a covenant in gross for TasWater with the registered proprietor/s of the Easement Land and their successors and assigns not to erect any building, or place any structures, objects, vegetation, or remove any thing that supports, protects or covers any Infrastructure on or in the Easement Land, without the prior written consent of TasWater to the intent that the burden of the covenant may run with and bind the servient land and every part thereof and that the benefit thereof may be annexed to the easement herein described.

Interpretation:

"Infrastructure" means infrastructure owned or for which TasWater is responsible and includes but is not limited to:

- (a) sewer pipes and water pipes and associated valves;
- (b) telemetry and monitoring devices;
- (c) inspection and access pits;
- (d) electricity assets and other conducting media (excluding telemetry and monitoring devices);
- (e) markers or signs indicating the location of the Easement Land or any other Infrastructure or any warnings or restrictions with respect to the Easement Land or any other Infrastructure;
- (f) anything reasonably required to support, protect or cover any other Infrastructure;

NOTE: Every annexed sheet must be signed by the parties to the dealing or where the party is a corporate body be signed by the persons who have attested the affixing of the seal of that body to the dealing.

Search Date: 04 Jul 2025 Search Time: 11:30 AM Volume Number: 185527 Revision Number: 03 Page 5 of 6



RECORDER OF TITLES

Issued Pursuant to the Land Titles Act 1980



ANNEXURE TO SCHEDULE OF EASEMENTS

PAGE 6 OF 6 PAGES

Registered Number

SP 185527

SUBDIVIDER: DFY INVESTMENT PTY LTD

FOLIO REFERENCE: C/T 36069/1

- (g) any other infrastructure whether of a similar nature or not to the preceding which is reasonably required for the piping of sewage or water, or the running of electricity, through the Easement Land or monitoring or managing that activity; and
- (h) where the context permits, any part of the Infrastructure.

"TasWater" means Tasmanian Water & Sewerage Corporation Pty Ltd (ACN 162 220 653), its successors and assigns.

Fencing Covenant

In respect of each lot on the Plan the Vendor, DFY INVESTMENT PTY LTD shall not be required to fence.

EXECUTED by DFY INVESTMENT

PTY LTD (ACN 649 916 914) pursuant to)
section 127(1) of the Corporations Act)
2001 by being signed by:

Signature

Signature

Signature

ANGELLO FLARALLO

Print name in BLOCK LETTERS

Print position held in BLOCK LETTERS

Print position held in BLOCK LETTERS

NOTE: Every annexed sheet must be signed by the parties to the dealing or where the party is a corporate body be signed by the persons who have attested the affixing of the seal of that body to the dealing.

Search Date: 04 Jul 2025 Search Time: 11:30 AM Volume Number: 185527 Revision Number: 03 Page 6 of 6