

Public Notice Details

Planning Application Details

Application No	DA2500129

Property Details

Property Location	6 Monteith Crescent Bagdad
-------------------	----------------------------

Application Information

Application Type	Discretionary Development Application
Development Category	Dwelling
Advertising Commencement Date	1/10/25
Advertising Closing Period	15/10/25
If the Council Offices are closed during normal office hours within the above period, the period for making representations is extended.	

Enquiries regarding this Application can be made via to Southern Midlands Council on (03) 6254 5050 or by emailing planningenquires@southernmidlands.tas.gov.au. Please quote the development application number when making your enquiry.

Representations on this application may be made to the General Manager in writing either by

Post: PO Box 21, Oatlands Tas 7120 Email: mail@southernmidlands.tas.gov.au

Fax: 03 6254 5014

All representations must include the authors full name, contact number and postal address and be received by the advertising closing date.





APPLICATION FOR PLANNING PERMIT – USE AND DEVELOPMENT Residential Use

Use this form to apply for planning approval in accordance with section 57 and 58 of the Land Use Planning and Approvals Act 1993

		• • • • • • • • • • • • • • • • • • • •					
Applicant / Owner Details:							
Owner / s Name	Wilson Homes Tasmania						
	250 Mur	250 Murray Street, Hobart					
Postal Address					Phone No:		
					Fax No:		
Email address:					sonya	a.gadd@v	wilsonhomes.com.au
Applicant Name (if not owner)	Wilson F	Homes P	TY LTD				
Postal Address:	250 Mur	ray Stree	et		Phone No:	(03) 621	39920
	Hobart			TAS	Fax No:		
Email address:	sonya.gadd@wilsonhomes.com.au						
Description of proposed use and/or development:							
Address of new use and development:	6 Monteith Creso	cent, Bagdad					
Certificate of Title No:	Volume No	185527		Lot No:	42		
Description of proposed use or development:	New Bui	lding -Dv	velling			Demoli / Carpo	v Dwelling /Additions/ tion / /Shed / Farm Building ort / Swimming Pool or other etc.
Current use of land and buildings:					Vacant land	buildi	are there any existing ngs on this title? , what is the main building as?
Is the property Heritage Listed	Please tick ✓answer Yes		No				
Proposed Material	What are the external wall		Brick/cladding		What is the propose material	d roof	Colourbond
	What are the external wall		TBC		What is the propose	d roof colour	TBC
	What is the բ new floor are		150.17		What is the estimate all the new work pro		\$399,230.00



Please attach any additional information that may be required by Part 6.1 Application Requirements of the Tasmanian Planning Scheme.

Signed Declaration	

I/we hereby apply for a planning approval to carry out the use or development described in this application and in the accompanying plans and documents, accordingly I declare that:

- 1. The information given is a true and accurate representation of the proposed development. I understand that the information and materials provided with this development application may be made available to the public. I understand that the Council may make such copies of the information and materials as, in its opinion, are necessary to facilitate a thorough consideration of the Development Application. I have obtained the relevant permission of the copyright owner for the communication and reproduction of the plans accompanying the development application, for the purposes of assessment of that application. I indemnify the Southern Midlands Council for any claim or action taken against it in respect of breach of copyright in respect of any of the information or material provided.
- 2. I am the applicant for the planning permit and I have notified the owner/s of the land in writing of the intention to make this application in accordance with Section 52(1) of the Land Use Planning Approvals Act 1993 (or the land owner has signed this form in the box below in "Land Owner(s) signature);

Applicant Signature (If not the Owner)	Applicant Name (Please print) Timothy Ribbons	Date 16/09/2025
Land Owner(s) Signature	Land Owners Name (please print) Wilson Homes Tasmania	Date 16/09/2025
Land Owner(s) Signature	Land Owners Name (please print)	Date



RESIDENTIAL DEVELOPMENT – Information & Checklist sheet

Use this check list for submitting your application

Submitting your application ✓

1.	All plans and information required per Application Requirements of the Planning Scheme www.iplan.tas.gov.au				
	ie: site plan showing all existing buildings, proposed buildings, elevation plans etc.				
2.	Copy of the current Certificate of Title, Schedule of Easements and Title Plan (Available from Service Tasmania Offices)				
3.	Any reports, certificates or written statements to accompany the Application (if applicable) required by the relevant zone or code.				
4.	Prescribed fees payable to Council				
In	formation				
pro Tra	ou provide an email address in this form then the Southern Midlands Council ("the Council") will treat the ovision of the email address as consent to the Council, pursuant to Section 6 of the Electronic ansactions Act 2000, to using that email address for the purposes of assessing the Application under the nd Use Planning and Approvals Act 1993 ("the Act").				
	ou provide an email address, the Council will not provide hard copy documentation unless specifically quested.				
	s your responsibility to provide the Council with the correct email address and to check your email for mmunications from the Council.				
If y	ou do not wish for the Council to use your email address as the method of contact and for the giving of				
info	ormation, please tick √ the box				
He	ritage Tasmania				
Не	If the Property is listed on the Tasmanian Heritage Register then the Application will be referred to Heritage Tasmania unless an Exemption Certificate has been provided with this Application. (Phone 1300 850 332 (local call cost) or email enquires@heritage.tas.gov.au)				
Та	sWater				
	pending on the works proposed Council may be required to refer the Application to TasWater for sessment (Phone 136992)				

PRIVACY STATEMENT

The Southern Midlands Council abides by the Personal Information Protection Act 2004 and views the protection of your privacy as an integral part of its commitment towards complete accountability and integrity in all its activities and programs.

Collection of Personal Information: The personal information being collected from you for the purposes of the Personal Information Protection Act, 2004 and will be used solely by Council in accordance with its Privacy Policy. Council is collecting this information from you in order to process your application.

Disclosure of Personal Information: Council will take all necessary measures to prevent unauthorised access to or disclosure of your personal information. External organisations to whom this personal information will be disclosed as required under the Building Act 2000. This information will not be disclosed to any other external agencies unless required or authorised by law.

Correction of Personal Information: If you wish to alter any personal information you have supplied to Council please telephone the Southern Midlands Council on (03) 62545050. Please contact the Council's Privacy Officer on (03) 6254 5000 if you have any other enguires concerning Council's privacy procedures.

ADVICE: There is no connection between Planning approval and Building & Plumbing approvals. Owners are to ensure that the work is either Low Risk Building Work, Notifiable Building Work or Permit work in accordance with the Directors Determination – Categories of Building & Demolition Work v 1.4 dated 12 March 2021.

https://www.cbos.tas.gov.au/ data/assets/pdf file/0014/405014/Directors-determination-categories-of-building-and-demolition-work-2021.pdf

SHEET INDEX

	COVER SHEET
2	SITE PLAN
3	SOIL & WATER MANAGEMENT PLAN
4	GROUND FLOOR PLAN
5	ELEVATIONS / SECTION
6	ELEVATIONS
7	WINDOW & DOOR SCHEDULES
8	ROOF DRAINAGE PLAN
9	FLOOR COVERINGS
10	KITCHEN DETAILS
11	BATHROOM DETAILS
12	ENGLITE DETAILS

TOTAL FLOOR AREAS

13 LAUNDRY DETAILS 14 3D VIEWS

MAIN DWELLING, GROUND FLOOR
ALERESCO.

	150.17 m²
PORCH	1.46
LIVING	134.59
ALFRESCO	14.13

AS & NCC COMPLIANCE

ALL CONSTRUCTION TO BE IN ACCORDANCE WITH NCC 2022 AND

- APPLICABLE AUSTRALIAN STANDARDS AT TIME OF APPROVAL.
 SLAB IN ACCORDANCE WITH AS 2870. REFER TO ENGINEERS DETAILS FOR ALL SLAB DETAILS.
- BRICK CONTROL JOINTS PROVIDED IN ACCORDANCE WITH NCC 2022. ALL STEEL FRAMING TO BE DESIGNED TO AS 4100-2020 OR AS/NZS
- INSULATION TO BE INSTALLED IN ACCORDANCE WITH NCC 2022 AND ALL APPLICABLE AUSTRALIAN STANDARDS.
- TERMITE PROTECTION IN ACCORDANCE WITH AS 3660 AND NCC 2022. GLAZING IN ACCORDANCE WITH AS 1288 AND NCC 2022.
- SMOKE ALARMS IN ACCORDANCE WITH AS 3786 AND NCC 2022. INTERNAL WATERPROOFING IN ACCORDANCE WITH NCC 2022 HOUSING PROVISIONS PART 10.2. EXTERNAL WATERPROOFING IN ACCORDANCE WITH AS 3740 AND AS
- WET AREA FLOORS TO FALL TO FLOOR WASTES AT MIN. 1:80 AND MAX.
- 1:50 GRADE (IF APPLICABLE). CONDENSATION MANAGEMENT IN ACCORDANCE WITH NCC 2019.
- BUILDING SEALING IN ACCORDANCE WITH NCC 2022. SERVICES IN ACCORDANCE WITH NCC 2022.
- EARTHWORKS IN ACCORDANCE WITH AS 3798-2007. EXTERNAL WALL WRAP (SARKING) IN ACCORDANCE WITH NCC 2022 (IF
- APPLICABLE).
 EXHAUST FANS DUCTED TO OUTSIDE AIR (IF APPLICABLE).

SITE SPECIFIC CONTROLS			
CONTROL	DETAILS		
ACID SULPHATE SOIL	NO		
BIODIVERSITY	NO		
BUILDING ENVELOPE	NO		
BUSHFIRE	TBC		
CLIMATE ZONE (NCC)	ZONE 7 - COOL TEMPERATE		
DESIGN WIND CLASSIFICATION	N2 (NOT EXPOSED)		
ESTATE/DEVELOPER GUIDELINES	NO		
FLOOD OVERLAY	NO		
HERITAGE	NO		
LANDSLIP HAZARD	NO		
MINIMUM FLOOR LEVEL	NO		
NATURAL ASSET CODE	NO		
NOISE ATTENUATION	NO		
SALINE SOIL	NO		
SHIELDING FACTOR	PS - PARTIAL SHIELDING		
SITE CLASSIFICATION	M		
SPECIFIC AREA PLAN OVERLAY	NO		
TERRAIN CATEGORY	TC2.5		
TOPOGRAPHIC CLASSIFICATION	Т0		
WATERWAY & COASTAL OVERLAY	NO		
WIND REGION	A - NORMAL		
WITHIN 1km CALM SALT WATER	NO		
WITHIN 50km BREAKING SLIRE	NO		


BUILDING CONTROLS & COMPLIANCE			
CONTROL	REQUIRED	PROPOSED	
SETBACKS		•	
FRONT	MIN. 4,500mm	5,350mm	
SIDE A	MIN. 3,000mm	4,500mm	
SIDE B	MIN. 3,000mm	3,350mm	
REAR	MIN. 3,000mm	12,900mm	
BULK & SCALE			
SITE AREA	613m²		
SITE COVERAGE	MAX. 50%	24.5%	
BUILDING HEIGHT	MAX. 8,500mm	4,700mm	
LANDSCAPE			
NO APPLICABLE CONTROLS			
EARTHWORKS			
CUT DEPTH	MAX. 2,000mm	427mm	
FILL DEPTH	MAX. 1,000mm	0mm	
ACCESS & AMENITY			
PARKING SPACES	MIN. 2 SPACES	2 SPACES	
PRIVATE OPEN SPACE	MIN. 24m²	24m²	

ALL

2025.09.09


TNG

3D PERSPECTIVE

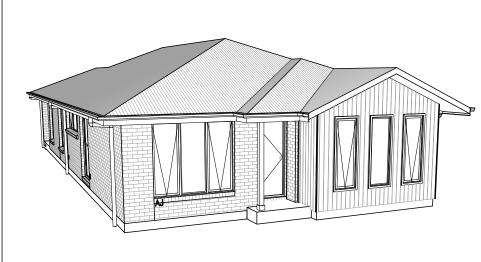

NOTE TO OWNER

THESE PLANS MAY FEATURE WORKS THAT ARE EXCLUDED FROM THE SCOPE OF WORKS WITH THE BUILDER, BUT THEY HAVE BEEN INCLUDED IN THESE DRAWINGS TO ASSIST IN THE OVERALL PLANNING AND ASSESSMENT OF THE BUILDING PROJECT. EXAMPLES OF SOME REGULARLY EXCLUDED WORKS INCLUDE DRIVEWAYS, RETAINING WALLS, SQUAR PANEL SPACING AND SITE DRAINAGE, PLEASE REFER TO YOUR SCOPE OF WORKS AND COLOUR SELECTIONS DOCUMENTATION FOR DETAILS OF INCLUDED WORKS. SOME DETAILS ARE INDICATIVE ONLY FOR EXAMPLE FLOORING, TILING, BRICKWORK AND CLADDING (EXPANSION JOINTS, ORIENTATION AND LAYOUT) AND ARE SUBJECT TO CHANGE.

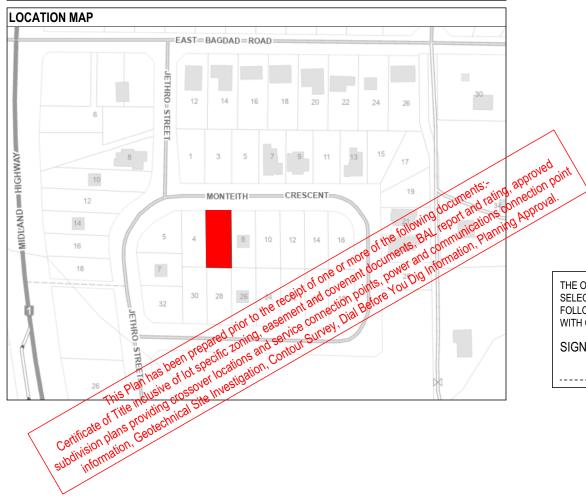

BUILDING INFORMATION GROUND FLOOR TOP OF WALL HEIGHT(S) 2445mm NOTE: CEILING HEIGHT 45mm LOWER THAN TOP OF WALL ROOF PITCH (UNO) SINGLE PHASE ELECTRICITY SUPPLY GAS SUPPLY NONE

OF MATERIAL	SHEET METAL
OF COLOUR	N/A
ALL MATERIAL	BRICK VENEER CLADDING
AR CLASSIFICATION	TRC

INSULATION

COVER SHEET

-			
ı		ROOF	SARKING UNDER ROOFING
ı		CEILING	R4.1 BATTS (EXCL. GARAGE, ALFRESCO & PATIO)
		EXT. WALLS	R2.0 BATTS (EXCL. GARAGE) WALL WRAP TO ENTIRE HOUSE
ı		INT. WALLS	R2.0 BATTS ADJACENT TO GARAGE AND AS PER PLAN
ı	Ш	FLOOR	BIAX SLAB R0 60

NCC 2022 LIVABLE HOUSING COMPLIANCE

ACCESSIBLE SANITARY COMPARTMENT: ENS ACCESSIBLE SHOWER LOCATION: BATH

GENERAL NOTES:

THRESHOLD OF ACCESSIBLE SHOWER ENTRY TO BE MAX. 5MM

- 1 EXTERIOR DOOR NOMINATED AS 870 OR GREATER TO ACHIEVE MIN 820MM CLEAR OPENING

- REFER TO APPLICABLE WET AREA PLANS AND INTERIOR ELEVATIONS OR LOCATIONS OF REQUIRED WALL REINFORCEMENT FOR FUTURE GRAB RAIL INSTALLATION.

THE OWNERS ACKNOWLEDGE THAT THESE CONTRACT PLANS MAY NOT REFLECT ALL THE SELECTIONS THAT HAVE BEEN MADE OR CHANGES REQUESTED. THE OWNERS AGREE THAT FOLLOWING THE COLOUR SELECTIONS VARIATION OR UPDATING OF PLANS, THEY WILL BE PROVIDED WITH CONSTRUCTION PLANS FOR SIGNATURE PRIOR TO COMMENCEMENT OF CONSTRUCTION.

1 / 14 1:100

SIGNATURE: DATE:

> **SUBJECT TO NCC 2022** (1 MAY 2023)

WATERPROOFING & PLUMBING

PLAN ACCEPTANCE BY OWNER SIGNATURE: DATE: SIGNATURE: DATE: PLEASE NOTE THAT VARIATIONS WILL NOT BE ACCEPTED AFTER THIS PLAN ACCEPTANCE HAS BEEN SIGNED

SHEET DATE DRAWN CHECK © 2025 WILSON HOMES PTY LTD (ABN 96 126 636 897). THIS DRAWING IS AN ORIGINAL ARTISTIC WORK WITHIN THE MEANING OF THE COPYRIGHT ACT 1968 (CTH). WILSON HOMES PTY LTD IS THE OWNER OF COPYRIGHT IN THIS DRAWING. YOU HEREBY AGREE AND UNDERTAKE THAT YOU WILL NOT

42 / - / 185527

	SPEC
WILSON	DIS
mir9011	COP
IIUW LC	© 2
ПППЕ?	

PRELIMINARY PLAN SET

PRELIMINARY PLAN SET - INITIAL ISSUE

AMENDMENT

No.

	IN ANY WAY REPRODUCE, COPY, MODIFY, USE OR TAKE ADVANTAGE OF THE DRAWING TO BUILD A HOUSE BASED ON THIS PLAN (WHETHER IN WHOLE OR IN PART) WITHOUT THE PRIOR WRITTEN CONSENT OF WILSON HOMES PTY LTD.						
SPECIFICATION:	REVISION	DRAWN CLIENT:		HOUSE DESIGN:		HOUSE CODE:	DO NOT SCALE DRAWINGS, USE
DISCOVERY	1 DRAFT SALES PLAN - CT1	MLG 25/08/2025 WILSON COMPLETE	≣	YORK 14		H-WDCYOR10SA	FIGURED DIMENSIONS ONLY. CHECK AND VERIFY DIMENSIONS AND
COPYRIGHT:	2 PLANS UPDATE	MLG 28/08/2025 ADDRESS:		FACADE DESIGN:		FACADE CODE:	LEVELS PRIOR TO THE COMMENCEMENT OF ANY WORK. ALL
© 2025	3 PRELIM PLANS - INITILAL ISSUE	TNG 09/09/2025 6 MONTEITH CR, BAG	GDAD TAS 7030	VERVE		F-WDCYOR10VERVA	DISCREPANCIES TO BE REPORTED TO THE DRAFTING OFFICE.
		LOT / SECTION / CT:	COUNCIL:	SHEET TITLE:	SHEET No.:	SCALES:	74444

SOUTHERN MIDLANDS


APPROX. CUT/FILL


SITE COVERAGE:


53 TONNES OF EXPORT FILL			
DIFFERENCE	23.45m³	52.76	
FILL	0.31m ³	0.70	
CUT	23.76m³	53.46	

LOT SIZE: 613m² HOUSE (COVERED AREA): 150.17m²

24.50%

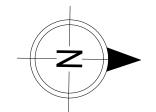

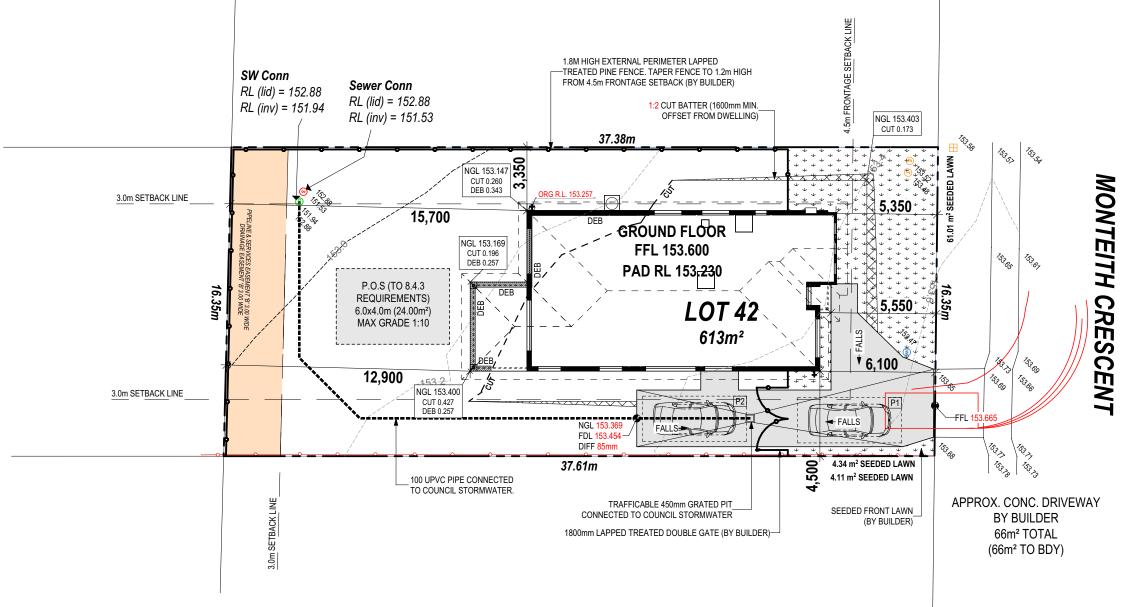

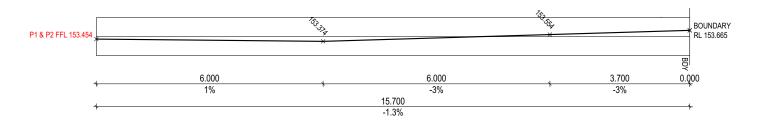

© 2025 WILSON HOMES PTY LTD (ABN 96 126 636 897). THIS DRAWING IS AN ORIGINAL ARTISTIC WORK WITHIN THE MEANING OF THE COPYRIGHT ACT 1968 (CTH). WILSON HOMES PTY LTD IS THE OWNER OF COPYRIGHT IN THIS DRAWING. YOU HEREBY AGREE AND UNDERTAKE THAT YOU WILL NOT IN ANY WAY REPRODUCE, COPY, MODIFY, USE OR TAKE ADVANTAGE OF THE DRAWING TO BUILD A HOUSE BASED ON THIS PLAN (WHETHER IN WHOLE OR IN PART) WITHOUT THE PRIOR WRITTEN CONSENT OF WILSON HOMES PTY LTD.

SUBJECT TO NCC 2022 (1 MAY 2023)
WATERPROOFING & PLUMBING

PLAN ACCEPTANCE B	Y OWNER
SIGNATURE:	DATE:
SIGNATURE:	DATE:

PLEASE NOTE THAT VARIATIONS WILL NOT BE ACCEPTED AFTER THIS PLAN ACCEPTANCE HAS BEEN SIGNED



		117111 1711 1121 1105002; 001 1; 110511 1; 002 011 1711271577		Statistic 1000LD Allocation and Allo				, i⊑	
	SPECIFICATION:	REVISION	5.0	CLIENT:		HOUSE DESIGN:	HOUSE CODE:	DO NOT SCALE DRAWINGS, USE	1
N	DISCOVERY 1	DRAFT SALES PLAN - CT1 ML0	LG 25/08/2025	WILSON COMPLETE		YORK 14	H-WDCYOR10SA	FIGURED DIMENSIONS ONLY. CHECK AND VERIFY DIMENSIONS AND LEVELS PRIOR TO THE	1.041
			LG 28/08/2025			FACADE DESIGN:	FACADE CODE:	COMMENCEMENT OF ANY WORK. ALL DISCREPANCIES TO BE REPORTED	
	© 2025 3	PRELIM PLANS - INITILAL ISSUE TNO	IG 09/09/2025	6 MONTEITH CR, BAGDA	AD TAS 7030	VERVE	F-WDCYOR10VERVA	TO THE DRAFTING OFFICE.	Versi
							No.: SCALES:	714414	plate
				42 / - / 185527	SOUTHERN MIDLANDS	SITE PLAN 2/	4 1:200	114414	e. e.


OWNERPROSTABLISE THE SITE ON COMPLETION OF THE BUILD WITH TURF LAWNS, GRASS SEEDS, NATIVE GROUND COVERS AND/ OR MULCH SPREAD TO A DEPTH OF 75-100mm


THE FOLLOWING IS A STANDARD
APPROACH. SEDIMENT AND EROSION
CONTROL MEASURES WILL BE REVIEWED
PRIOR TO COMMENCING WORK AND
INSTALLED BASED ON THE OUTCOME OF
THAT REVIEW.


NOTES


1. ALL EROSION AND SEDIMENT CONTROL STRUCTURES TO BE INSPECTED EACH WORKING DAY AND MAINTAINED IN GOOD WORKING ORDER.


- 2. ALL GROUND COVER VEGETATION
 OUTSIDE THE IMMEDIATE BUILDING AREA
 TO BE PRESERVED DURING THE BUILDING
 PHASE
- 3. ALL EROSION AND SEDIMENT CONROL MEASURES TO BE INSTALLED PRIOR TO COMMENCEMENT OF MAJOR EARTHWORKS.
- 4. STOCKPILES OF CLAYEY MATERIAL TO
 BE COVERED WITH AN IMPERVIOUS SHEET.
 5. ROOF WATER DOWNPIPES TO BE
 CONNECTED TO THE PERMAMENT.
- CONNECTED TO THE PERMAMENT UNDERGROUND STORMWATER DRAINAGE SYSTEM AS SOON AS PRACTICAL AFTER THE ROOF IS LAID.
- 6. DIVERSION DRAINS ARE TO BE CONNECTED TO A LEAGAL DISCHARGE POINT (COUNCIL STORMWATER SYSTEM, WATERCOURSE OR ROAD DRAIN).
 7. SEDIMENT RETENTION TRAPS INSTALLED AROUND THE INLETS TO THE STORMWATER SYSTEM TO PREVENT SEDIMENT & OTHER DEBRIS BLOCKING THE DRAINS.

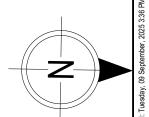

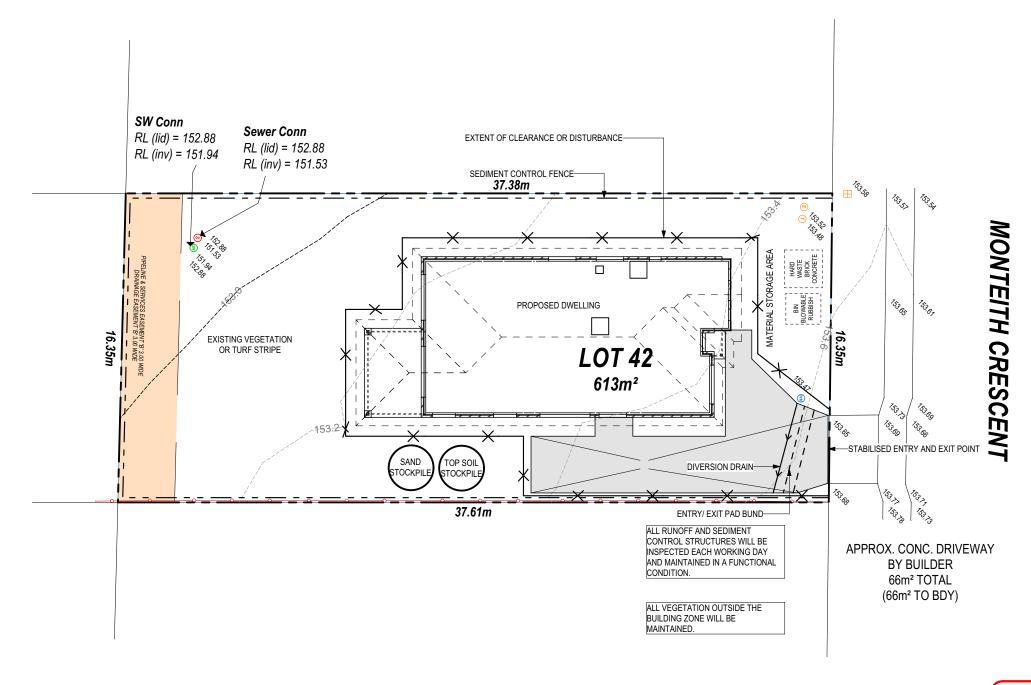

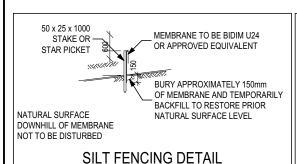

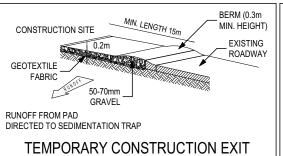

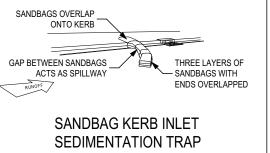

SUBJECT TO NCC 2022 (1 MAY 2023)

WATERPROOFING & PLUMBING

PLAN ACCEPTANCE BY OWNER SIGNATURE: DATE: SIGNATURE: DATE: PLEASE NOTE THAT VARIATIONS WILL NOT BE ACCEPTED AFTER THIS PLAN ACCEPTANCE HAS BEEN SIGNED

© 2025 WILSON HOMES PTY LTD (ABN 96 126 636 897). THIS DRAWING IS AN ORIGINAL ARTISTIC WORK WITHIN THE MEANING OF THE COPYRIGHT ACT 1968 (CTH), WILSON HOMES PTY LTD IS THE OWNER OF COPYRIGHT IN THIS DRAWING. YOU HEREBY AGREE AND UNDERTAKE THAT YOU WILL NOT IN ANY WAY REPRODUCE, COPY, MODIFY, USE OR TAKE ADVANTAGE OF THE DRAWING TO BUILD A HOUSE BASED ON THIS PLAN (WHETHER IN WHOLE OR IN PART) WITHOUT THE PRIOR WRITTEN CONSENT OF WILSON HOMES PTY LTD.



	HAM THE ROBOUL ON THE DISTRICT OF THE SIGNATURE OF BOLES AT HIGH ENGLISH WHITE CONTRACT OF THE FROM THE FROM THE FIRST THE FOR THE FIRST				, iE				
SPECIFICATION:	REVISION	DRAWN	CLIENT:		HOUSE DESIGN:		HOUSE CODE:	DO NOT SCALE DRAWINGS, USE	1
DISCOVERY	1 DRAFT SALES PLAN - CT1 ML0	3 25/08/2025	WILSON COMPLETE		YORK 14		H-WDCYOR10SA	FIGURED DIMENSIONS ONLY. CHECK AND VERIFY DIMENSIONS AND	140
COPYRIGHT:		3 28/08/2025			FACADE DESIGN:			LEVELS PRIOR TO THE COMMENCEMENT OF ANY WORK. ALL	
© 2025	3 PRELIM PLANS - INITILAL ISSUE TNO	9 09/09/2025	6 MONTEITH CR, BAGI	DAD TAS 7030	VERVE		F-WDCYOR10VERVA	DISCREPANCIES TO BE REPORTED TO THE DRAFTING OFFICE.	Versic
			LOT / SECTION / CT:	COUNCIL:	SHEET TITLE:		SCALES:	714414	olate
			42 / - / 185527	SOUTHERN MIDLANDS	SOIL & WATER MANAGEMENT PLAN	3 / 14	1:200	<i> </i>	e e

Template Version: 24.041 File Location: D:TuyenJOBS\714414 - Wilson Complete - 6 N

ANY PART OF THE FASCIA, GUTTERING OR DOWNPIPE THAT IS WITHIN 450mm OF ANY BOUNDARY IS TO BE NON-COMBUSTIBLE IN ACCORDANCE WITH NCC 2022

ALL EXTERIOR SLABS TO BE GRADED BY CONCRETER TO ACHIEVE APPROX. 1:100 FALL TO OUTSIDE EDGE WITH MAXIMUM CROSSFALL OF 30mm OVER ENTIRE SLAB.

REFERT O SHEET) FOR ALL BUILDING INFORMATION REGARDING: SUSTAINABILITY REQUIREMENTS

SITE CLASSIFICATION GENERAL BUILDING INFORMATION

ALL MECHANICAL VENTILATION TO BE DISCHARGED TO OUTDOOR AIR AS PER NCC 2022 REQUIREMENTS


FIRE RESISTANT PLASTERBOARD TO BE INSTALLED BEHIND COOKTOP

ALL GROUND FLOOR BULKHEAD AND SQUARE SET OPENING FRAMES TO BE 2155 ABOVE FFL UNLESS NOTED OTHERWISE

REFER TO WINDOW AND DOOR SCHEDULES FOR FULL DETAILS OF ALL WINDOWS AND DOORS. PLEASE NOTE WINDOW AND DOOR SIZES ARE BASED ON DEPOSIT STAGE AND MAY DIFFER SLIGHTLY TO THE SIZES NOMINATED IN THE SCOPE OF WORKS DUE TO MANUFACTURING CHANGES AT THE TIME OF CONSTRUCTION.

FINAL WINDOW AND EXTERIOR DOOR LOCATIONS MAY BE ADJUSTED ON SITE TO SUIT BRICKWORK GAUGE

UNLESS NOTED OTHERWISE ALL ROOMS ARE REFERENCED AS FOLLOWS:

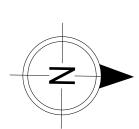

LEGEND HS / WS HOB SPOUT / WALL SPOUT

FACE BRICK / COMMON BRICK

SOUND INSULATION

BRICK ARTICULATION JOINT SDP STANDARD DOWNPIPE

CDP CHARGED DOWNPIPE DENOTES DRAWER SIDE 3D

MECHANICAL VENTILATION L.B.W

LOAD BEARING WALL PLASTERBOARD


FC FIBRE CEMENT THIS DOOR OPENS FIRST IJ,

SMOKE ALARM

LIFT OFF HINGE +

WATER POINT


GAS BAYONET

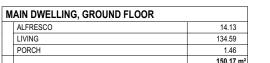



3,100 KITCHEN

90, 950 HALL, 90

3,000 ROBE

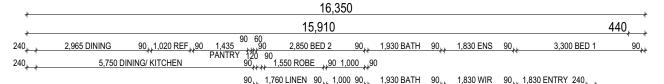

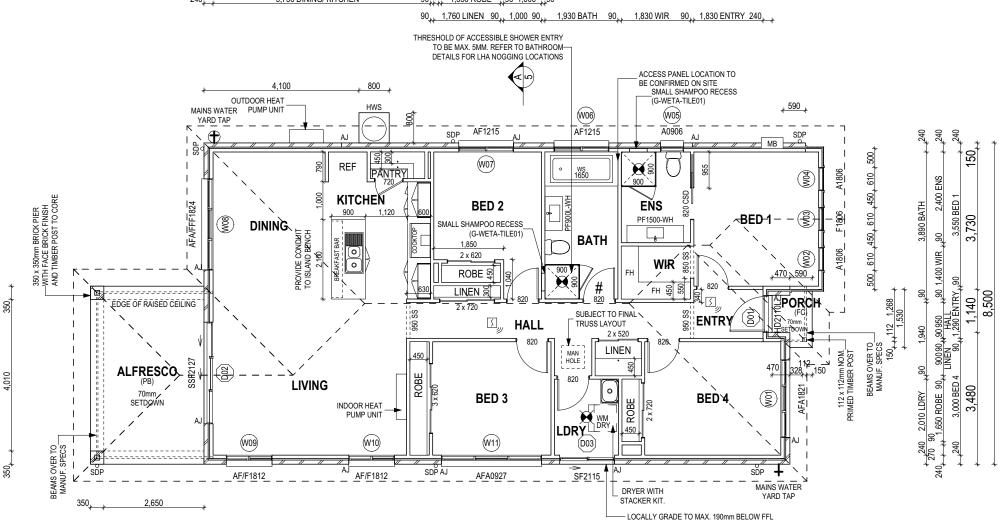

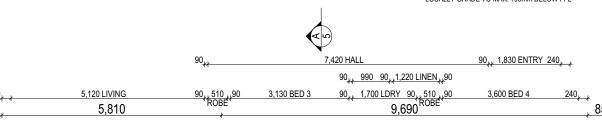

ALL DIMENSIONS ARE FRAME DIMENSIONS

© 2025 WILSON HOMES PTY LTD (ABN 96 126 636 897). THIS DRAWING IS AN ORIGINAL ARTISTIC WORK WITHIN THE MEANING OF THE COPYRIGHT ACT 1968 (CTH). WILSON HOMES PTY LTD IS THE OWNER OF COPYRIGHT IN THIS DRAWING. YOU HEREBY AGREE AND UNDERTAKE THAT YOU WILL NOT IN ANY WAY REPRODUCE, COPY, MODIFY, USE OR TAKE ADVANTAGE OF THE DRAWING TO BUILD A HOUSE BASED ON THIS PLAN (WHETHER IN WHOLE OR IN PART) WITHOUT THE PRIOR WRITTEN CONSENT OF WILSON HOMES PTY LTD.

PLAN ACCEPTANCE B	Y OWNER
SIGNATURE:	DATE:
SIGNATURE:	DATE:

SUBJECT TO NCC 2022

(1 MAY 2023)

WATERPROOFING & PLUMBING

PLEASE NOTE THAT VARIATIONS WILL NOT BE ACCEPTED AFTER THIS PLAN ACCEPTANCE HAS BEEN SIGNED



		ment that the responsible of the second of t	.,	3.50 miles 10.50 miles 2.50 miles 2.50 (miles 2.50 miles 2.50 mile				ĮŒ	
	SPECIFICATION:	REVISION	DRAWN	CLIENT:		HOUSE DESIGN:	HOUSE CODE:	DO NOT SCALE DRAWINGS, USE	1
n	DISCOVERY 1	DRAFT SALES PLAN - CT1 ML	LG 25/08/2025	WILSON COMPLETE		YORK 14	H-WDCYOR10SA	FIGURED DIMENSIONS ONLY. CHECK AND VERIFY DIMENSIONS AND LEVELS PRIOR TO THE	1.041
			LG 28/08/2025			FACADE DESIGN:	FACADE CODE:	COMMENCEMENT OF ANY WORK. ALL DISCREPANCIES TO BE REPORTED	
	© 2025	PRELIM PLANS - INITILAL ISSUE TN	NG 09/09/2025	6 MONTEITH CR, BAGDA	AD TAS 7030	VERVE	F-WDCYOR10VERVA	TO THE DRAFTING OFFICE.	Versi
						I I	FNo.: SCALES:	714414	plate
				42 / - / 185527	SOUTHERN MIDLANDS	GROUND FLOOR PLAN 4/	4 1:100	<i> </i> 44 4	e e

ROOMS OTHER THAN BEDROOM WINDOW OPENINGS ABOVE 4m OFF THE SURFACE BENEATH TO BE RESTRICTED AS REQUIRED BY NCC 11.3.7 (VOLUME TWO)

REFER TO THE FOLLOWING DETAILS: BRICK COURSING W-BRIC-001


SOME DETAILS ON THIS SHEET ARE INDICATIVE ONLY FOR EXAMPLE BRICKWORK AND CLADDING (EXPANSION JOINTS, ORIENTATION AND LAYOUT) AND ARE SUBJECT TO CHANGE. SH = SNAP HEADER SILL BEDROOM WINDOW OPENINGS ABOVE 2m OFF THE SURFACE BENEATH TO BE RESTRICTED AS REQUIRED BY NCC 11.3.7 (VOLUME TWO)

NORTH ELEVATION SCALE: 1:100


-ENTRY DOOR

POST

112 x 112mm NOM. PRIMED TIMBER___

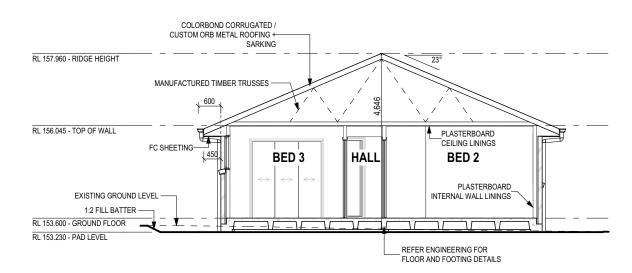


SECTION A-A SCALE: 1:100

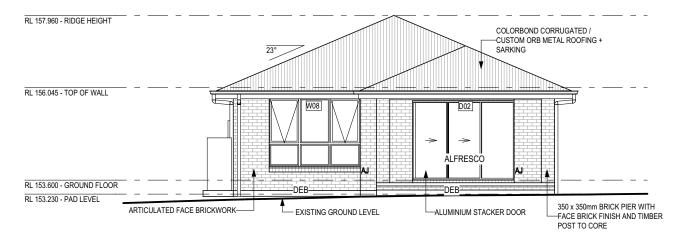

SOUTH ELEVATION SCALE: 1:100

SUBJECT TO NCC 2022 (1 MAY 2023)

WATERPROOFING & PLUMBING

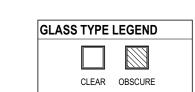

WINDOV	V TYPE I	LEGEND			
	\ \ \			→	
AWNING	DOUBLE HUNG	FIXED	LOUVRE	SLIDI	ING

PLAN ACCEPTANCE BY OWNER SIGNATURE: DATE: SIGNATURE: DATE: PLEASE NOTE THAT VARIATIONS WILL NOT BE ACCEPTED AFTER THIS PLAN ACCEPTANCE HAS BEEN SIGNED

© 2025 WILSON HOMES PTY LTD (ABN 96 126 636 897). THIS DRAWING IS AN ORIGINAL ARTISTIC WORK WITHIN THE MEANING OF THE COPYRIGHT ACT 1968 (CTH). WILSON HOMES PTY LTD IS THE OWNER OF COPYRIGHT IN THIS DRAWING. YOU HEREBY AGREE AND UNDERTAKE THAT YOU WILL NOT

JAMES HARDIE SCYON AXON

133mm SMOOTH CLADDING

JAMES HARDIE ALUMINIUM EXTERNAL BOX CORNER

45mm NOM. MOULDING TO

WILSON
HOMES

SMC - KEMPTON **RECEIVED**

16/09/2025

RL 157.96 - RIDGE HEIGHT

RL 156.045 - TOP OF WALL

RL 153.600 - GROUND FLOOR

RL 153.230 - PAD LEVEL

ARTICULATED FACE BRICKWORK-

EXISTING GROUND LEVEL 1:2 CUT BATTER

COLORBOND CORRUGATED / CUSTOM ORB METAL ROOFING +-

		IN ANY WAY REPRODUCE, COPY, MODIFY, USE OR TAKE	ADVANTAGE OF THE	DRAWING TO BUILD A HOUSE BASED C	ON THIS PLAN (WHETHER IN WHOLE OR IN PART) WITHOUT THE PRIOF	R WRITTEN CONSENT OF WILSON HOMES PTY LTD.				E E
	SPECIFICATION:	REVISION	DRAWN	CLIENT:		HOUSE DESIGN:		HOUSE CODE:	DO NOT SCALE DRAWINGS, USE FIGURED DIMENSIONS ONLY. CHECK	l
1	DISCOVERY	1 DRAFT SALES PLAN - CT1	MLG 25/08/2025	WILSON COMPLETE		YORK 14		H-WDCYOR10SA	AND VERIFY DIMENSIONS AND LEVELS PRIOR TO THE	.04
L	COPYRIGHT:	2 PLANS UPDATE	MLG 28/08/2025	ADDRESS:		FACADE DESIGN:		FACADE CODE:	COMMENCEMENT OF ANY WORK. ALL	
_	© 2025	3 PRELIM PLANS - INITILAL ISSUE	TNG 09/09/2025	6 MONTEITH CR, BAGDA	AD TAS 7030	VERVE		F-WDCYOR10VERVA	DISCREPANCIES TO BE REPORTED TO THE DRAFTING OFFICE.	/ersio
				LOT / SECTION / CT:	COUNCIL:	SHEET TITLE:	SHEET No.:	SCALES:	711111	ate
				42 / - / 185527	SOUTHERN MIDLANDS	ELEVATIONS / SECTION	5 / 14	1:100	714414	emp

REFER TO SHEET 1 (COVER SHEET) FOR ALL BUILDING INFORMATION REGARDING: SUSTAINABILITY REQUIREMENTS SITE CLASSIFICATION

GENERAL BUILDING INFORMATION

SOME DETAILS ON THIS SHEET ARE INDICATIVE ONLY FOR EXAMPLE BRICKWORK AND CLADDING (EXPANSION JOINTS, ORIENTATION AND LAYOUT) AND ARE SUBJECT TO CHANGE.


SH = SNAP HEADER SILL

BEDROOM WINDOW OPENINGS ABOVE 2m OFF THE SURFACE BENEATH TO BE RESTRICTED AS REQUIRED BY NCC 11.3.7 (VOLUME TWO)

ROOMS OTHER THAN BEDROOM WINDOW OPENINGS ABOVE 4m OFF THE SURFACE BENEATH TO BE RESTRICTED AS REQUIRED BY NCC 11.3.7 (VOLUME TWO)

REFER TO THE FOLLOWING DETAILS: BRICK COURSING W-BRIC-001

EAST ELEVATION SCALE: 1:100

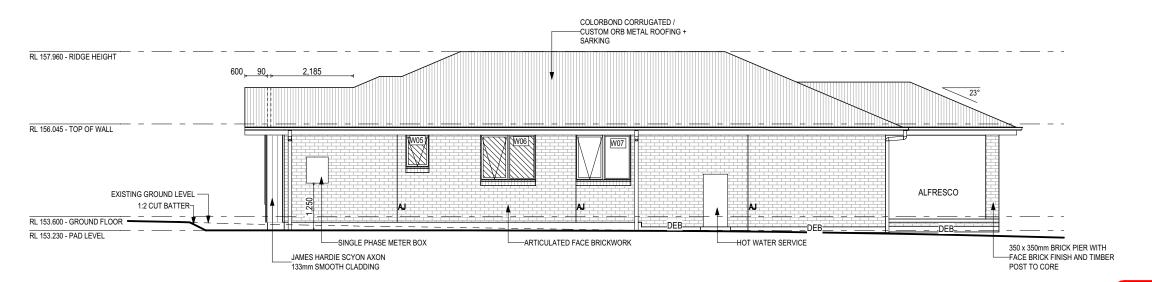

WEST ELEVATION SCALE: 1:100

© 2025 WILSON HOMES PTY LTD (ABN 96 126 636 897). THIS DRAWING IS AN ORIGINAL ARTISTIC WORK WITHIN THE MEANING OF THE COPYRIGHT ACT 1968 (CTH). WILSON HOMES PTY LTD IS THE OWNER OF COPYRIGHT IN THIS DRAWING. YOU HEREBY AGREE AND UNDERTAKE THAT YOU WILL NOT

WINDOW TYPE LEGEND

GLASS TYPE LEGEND

CLEAR

OBSCURE

DOUBLE LOUVRE SLIDING

PLAN ACCEPTANCE BY OWNER SIGNATURE: DATE: SIGNATURE: DATE:

PLEASE NOTE THAT VARIATIONS WILL NOT BE ACCEPTED AFTER THIS PLAN ACCEPTANCE HAS BEEN SIGNED

> DO NOT SCALE DRAWINGS, USE FIGURED DIMENSIONS ONLY. CHECK AND VERIFY DIMENSIONS AND LEVELS PRIOR TO THE COMMENCEMENT OF ANY WORK. AL DISCREPANCIES TO BE REPORTED TO THE DRAFTING OFFICE.

> > 714414

SUBJECT TO NCC 2022

(1 MAY 2023)

WATERPROOFING & PLUMBING

	IN ANY WAY REPRODUCE, COPY, MODIFY, USE OR	TAKE ADVAI	NTAGE OF THE	DRAWING TO BUILD A HOUSE BASED (ON THIS PLAN (WHETHER IN WHOLE OR IN PART) WITH	OUT THE PRIOR WRITTEN CO	ONSENT OF WILSON HOMES PTY LTD.		
SPECIFICATION:	REVISION		DRAWN	CLIENT:			HOUSE DESIGN:		HOUSE CODE:
DISCOVERY	1 DRAFT SALES PLAN - CT1	MLG	25/08/2025	WILSON COMPLETE			YORK 14		H-WDCYOR10SA
COPYRIGHT:	2 PLANS UPDATE	MLG	28/08/2025	ADDRESS:			FACADE DESIGN:		FACADE CODE:
© 2025	3 PRELIM PLANS - INITILAL ISSUE	TNG	09/09/2025	6 MONTEITH CR, BAGD	AD TAS 7030		VERVE		F-WDCYOR10VERVA
				LOT / SECTION / CT:	COUNCIL:		SHEET TITLE:	SHEET No.:	SCALES:
				42 / - / 185527	SOUTHERN MIDLANDS		ELEVATIONS	6 / 14	1:100

RECEIVED STOREY 16/09/2025	ID	CODE ¹	TYPE	ROOM	HEIGHT	WIDTH	PERIMETER	AREA FRAME (m²) TYPE	BAL RATING	SILL TYPE	ORIENT.	GLAZING AREA (m²)	GLAZING TYPE (SINGLE GLAZING U.N.O.)	ADDITIONAL INFORMATION ²
/INDOW														
GROUND FLOOR	W01	AFA1821	AWNING	BED 4	1,800	2,050	7,700	3.69 ALUMINIUM	N/A	SNAP HEADER	N	2.92	CLEAR, DOUBLE GLAZED	MP 683-683
GROUND FLOOR	W02	A1806	AWNING	BED 1	1,800	610	4,820	1.10 ALUMINIUM	N/A	NONE	N	0.81	CLEAR, DOUBLE GLAZED	
GROUND FLOOR	W03	F1806	FIXED	BED 1	1,800	610	4,820	1.10 ALUMINIUM	N/A	NONE	N	0.93	CLEAR, DOUBLE GLAZED	
GROUND FLOOR	W04	A1806	AWNING	BED 1	1,800	610	4,820	1.10 ALUMINIUM	N/A	NONE	N	0.81	CLEAR, DOUBLE GLAZED	
GROUND FLOOR	W05	A0906	AWNING	ENS	857	610	2,934	0.52 ALUMINIUM	N/A	ANGLED	W	0.35	OBSCURE, DOUBLE GLAZED, TOUGHENED	
GROUND FLOOR	W06	AF1215	AWNING	BATH	1,200	1,450	5,300	1.74 ALUMINIUM	N/A	ANGLED	W	1.38	OBSCURE, DOUBLE GLAZED, TOUGHENED	MP 725
GROUND FLOOR	W07	AF1215	AWNING	BED 2	1,200	1,450	5,300	1.74 ALUMINIUM	N/A	ANGLED	W	1.38	CLEAR, DOUBLE GLAZED	MP 725
GROUND FLOOR	W08	AFA/FFF1824	AWNING	DINING	1,800	2,410	8,420	4.34 ALUMINIUM	N/A	ANGLED	S	3.43	CLEAR, DOUBLE GLAZED	BP 600, MP 803-803/803-803
GROUND FLOOR	W09	AF/F1812	AWNING	LIVING	1,800	1,210	6,020	2.18 ALUMINIUM	N/A	ANGLED	Е	1.72	CLEAR, DOUBLE GLAZED	BP 600, MP 0/605
GROUND FLOOR	W10	AF/F1812	AWNING	LIVING	1,800	1,210	6,020	2.18 ALUMINIUM	N/A	ANGLED	Е	1.72	CLEAR, DOUBLE GLAZED	BP 600, MP 0/605
GROUND FLOOR	W11	AFA0927	AWNING	BED 3	857	2,650	7,014	2.27 ALUMINIUM	N/A	ANGLED	Е	1.74	CLEAR, DOUBLE GLAZED	MP 883-883
							63,168 mm	21.95				17.18		
OOR		•	<u> </u>	•	'		-			•				
GROUND FLOOR	D01	HD2110L	SWINGING	ENTRY	2,100	970	6,140	2.04 ALUMINIUM	N/A	SNAP HEADER	N	1.41	N/A	
GROUND FLOOR	D02	SSF2127	STACKER	LIVING	2,100	2,688	9,576	5.64 ALUMINIUM	N/A	SNAP HEADER	S	4.96	CLEAR, DOUBLE GLAZED, TOUGHENED	
GROUND FLOOR	D03	SF2115	SLIDING	LDRY	2,100	1,450	7,100	3.05 ALUMINIUM	N/A	SNAP HEADER	Е	2.59	CLEAR, DOUBLE GLAZED, TOUGHENED	
							22,816 mm	10.73				8.96		
							85.984 mm	32.68				26.13		

No BAL / BAL 12.5				
Window Type	WE	RS Code	U Value	SHGC
Sliding Window	DO	W-022-003	2.9	0.64
Awning Window	DO	W-005-001	3.9	0.58
Fixed External Window	DO	W-038-001	3.03	0.71
Sliding Door	DAI	R-034-001	3.97	0.63
Stacking Door	DAI	R-034-001	3.97	0.63
Hinged Door	DO'	W-017-001	4.1	0.55
Bi-Fold Door	DO	W-020-001	4.1	0.54
BAL 19				
Window Type	WE	RS Code	U Value	SHGC
Sliding Window	TNI	0-034-001	3.1	0.61
Awning Window	STO	3-001-066	3.91	0.54
Fixed External Window	DO	W-038-005	3.02	0.66
Sliding Door	AU\	N-009-009		0.58
Stacking Door	_	N-009-009		0.58
Hinged Door	GR	N-009-001	4.25	0.53
Bi-Fold Door	DO'	W-020-001	4.1	0.54
BAL 29				
Window Type	WE	RS Code	U Value	SHGC
Sliding Window	TNI	D-034-001	3.1	0.61
Awning Window	STO	G-001-066	3.91	0.54
Fixed External Window	/ DO	W-038-005	3.02	0.66
Sliding Door	AM	J-007-005	4.03	0.59
Stacking Door	AM	J-007-005	4.03	0.59
Hinged Door	GR	N-009-001	4.29	0.53
-				
NOTE:				
Windows supplied MUS				
and SHGC within +/- 5			ed windows t	o have
their openability restrict				
PICTURE, TV RECE	SS AND SS WII	NDOW OP	FNINGS	
QTY TYPE	HEIGHT	WIDTH	AREA (m²)	
WII IIFE	пеіопі	MIDIU	AKEA (III)	

2 x 620 ROBEMAKER SLIDING 2,040 1,260 N/A 2 x 720 ROBEMAKER SLIDING 2,040 1,460 N/A

820 N/A

820 N/A

850 N/A

3 PRELIM PLANS - INITILAL ISSUE

2 PLANS UPDATE

1,060 N/A

2,040

2,040

2,040

2,155

2,155

HEIGHT WIDTH GLAZING TYPE ADDITIONAL INFORMATION

GROUND FLOOR 1 GROUND FLOOR 2 GROUND FLOOR 3 x 620 ROBEMAKER SLIDING 2,040 1,860 N/A GROUND FLOOR 1 720 SWINGING 2,040 720 N/A GROUND FLOOR 5 820 SWINGING 2,040 820 N/A

SWINGING

ROBEMAKER SLIDING

TYPE

GROUND FLOOR 820 CSD **CAVITY SLIDING** GROUND FLOOR 1 850 SS SQUARE SET OPENING GROUND FLOOR 2 SQUARE SET OPENING 950 SS

950 N/A

NOTE: INTERNAL DOORS TO WET AREAS WITH MECHANICAL VENTILATION TO BE UNDERCUT 20mm

MLG 28/08/2025 ADDRESS:

LIFT-OFF HINGES

IIIII con	SPECIFICATION: DISCOVERY
mir2011	COPYRIGHT:
IIUWIC	© 2025
ПППЕ?	

INTERIOR WINDOW & DOOR SCHEDULE QTY CODE

2 x 520

820

DOOR

GROUND FLOOR 1

GROUND FLOOR

REFER TO SHEET 1 (COVER SHEET) FOR ALL BUILDING INFORMATION REGARDING:

SUSTAINABILITY REQUIREMENTS SITE CLASSIFICATION

GENERAL BUILDING INFORMATION

SOUTHERN MIDLANDS

© 2025 WILSON HOMES	(IN THE MEANING OF THE COPYRIGHT ACT 1968 (CTH). WILSON HOMES PTY LTD IS THE OWNER OF COPYRIGHT IN THIS DF E DRAWING TO BUILD A HOUSE BASED ON THIS PLAN (WHETHER IN WHOLE OR IN PART) WITHOUT THE PRIOR WRITTEN C	
	REVISION	DRAWN	CLIENT:	HOUSE DESIGN:
	1 DRAFT SALES PLAN - CT1	MLG 25/08/2025	WILSON COMPLETE	YORK 14

TNG 09/09/2025 6 MONTEITH CR, BAGDAD TAS 7030

LOT / SECTION / CT:

42 / - / 185527

EN C	JNSENT OF WILSON HOMES PTY LTD.		-
	HOUSE DESIGN:		HOUSE CODE:
	YORK 14		H-WDCYOR10SA
	FACADE DESIGN:		FACADE CODE:
	VERVE		F-WDCYOR10VERVA
	SHEET TITLE:	SHEET No.:	SCALES:
	WINDOW & DOOR SCHEDULES	7 / 14	

DO NOT SCALE DRAWINGS, USE FIGURED DIMENSIONS ONLY. CHECK FIGURED DIMENSIONS ONLY. CHECK AND VERIFY DIMENSIONS AND LEVELS PRIOR TO THE COMMENCEMENT OF ANY WORK. ALL DISCREPANCIES TO BE REPORTED TO THE DRAFTING OFFICE.

DATE:

DATE:

SUBJECT TO NCC 2022

(1 MAY 2023)

WATERPROOFING & PLUMBING


PLAN ACCEPTANCE BY OWNER

PLEASE NOTE THAT VARIATIONS WILL NOT BE ACCEPTED AFTER THIS PLAN ACCEPTANCE HAS BEEN SIGNED

SIGNATURE:

SIGNATURE:

714414

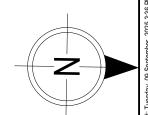

3,000 17,400

CATCHMENT AREA CATCHMENT AREA 31.38 m² 32.60 m² CATCHMENT AREA 28.27 m² CATCHMENT AREA CATCHMENT AREA 34.13 m² 34.76 m² CATCHMENT AREA 25.27 m²

19,400

WHERE DOWNPIPES ARE FURTHER THAN 1.2m AWAY FROM VALLEY REFER TO N.C.C. 7.3.5(2)

POSITION AND QUALITY OF DOWNPIPES ARE NOT TO BE ALTERED WITHOUT CONSULTATION WITH DESIGNER.

AREA'S SHOWN ARE SURFACE AREAS/ CATCHMENT AREAS, NOT PLAN AREAS

Roofi	ng Data	
	176.73	Flat Roof Area (excluding gutter and slope factor) (m²)
	192.00	Roof Surface Area (includes slope factor, excludes gutter) (m²)
Dowr	pipe roof	calculations (as per AS/NZA3500.3:2021)
Ah	186.41	Area of roof catchment (including 115mm Slotted Quad Gutter) (m²)
Ac	225.56	Ah x Catchment Area Multiplier for slope (Table 3.4.3.2 from AS/NZS 3500.3:2021) (1.21 for 23° pitch) (m²)
Ae	6300	Cross sectional area of 57 x 115 Slotted Quad Gutter (mm²)
DRI	86	Design Rainfall Intensity (determined from Table E1 from AS/NZS 3500.3:2021)
Acdp	64	Catchment area per Downpipe (determined from Figure 3.5(A) from AS/NZS 3500.3:2021) (m²)
Required Downpipes	3.52	Ac / Acdp
Downpipes Provided	6	

SOFFIT EAVE VENT PROPOSED LOCATION TO BE MIN. 1M FROM CORNER JOINT

590 410

SUBJECT TO NCC 2022 (1 MAY 2023) WATERPROOFING & PLUMBING

ſ	PLAN ACCEPTAN	CE BY OWNER		10.41
	SIGNATURE:	DATE:		7777
	SIGNATURE:	DATE:		H
	PLEASE NOTE THAT VARIATION	S WILL NOT BE ACCEPTED		
1	AFTER THIS PLAN ACCEPTAN	NCE HAS BEEN SIGNED	<i>)</i>	

© 2025 WILSON HOMES PTY LTD (ABN 96 126 636 897). THIS DRAWING IS AN ORIGINAL ARTISTIC WORK WITHIN THE MEANING OF THE COPYRIGHT ACT 1968 (CTH), WILSON HOMES PTY LTD IS THE OWNER OF COPYRIGHT IN THIS DRAWING. YOU HEREBY AGREE AND UNDERTAKE THAT YOU WILL NOT IN ANY WAY REPRODUCE, COPY, MODIFY, USE OR TAKE ADVANTAGE OF THE DRAWING TO BUILD A HOUSE BASED ON THIS PLAN (WHETHER IN WHOLE OR IN PART) WITHOUT THE PRIOR WRITTEN CONSENT OF WILSON HOMES PTY LTD.

	INTERT WITH REPRODUCE, COLLI, MODIL 1, COL CIT WILE NOW	NINOL OF THE	DIVINITO TO BOILD ATTIOCOL BACEL	S SI THIS E BIT (WIETER IN WHOLE SICILITY WITH SO THE THIS WITH TELL	CONCENT OF WILCONTHOMICOT IT ETD.				, iE
SPECIFICATION:	REVISION	DRAWN	CLIENT:		HOUSE DESIGN:		HOUSE CODE:	DO NOT SCALE DRAWINGS, USE]
DISCOVERY	1 DRAFT SALES PLAN - CT1 MLC	25/08/2025	WILSON COMPLETE		YORK 14		H-WDCYOR10SA	FIGURED DIMENSIONS ONLY. CHECK AND VERIFY DIMENSIONS AND	.041
COPYRIGHT:		28/08/2025			FACADE DESIGN:			LEVELS PRIOR TO THE COMMENCEMENT OF ANY WORK. ALL	
© 2025	3 PRELIM PLANS - INITILAL ISSUE TNO	09/09/2025	6 MONTEITH CR, BAGE	DAD TAS 7030	VERVE		F-WDCYOR10VERVA	DISCREPANCIES TO BE REPORTED TO THE DRAFTING OFFICE.	Versic
			LOT / SECTION / CT:	COUNCIL:			SCALES:	714414	olate '
			42 / - / 185527	SOUTHERN MIDLANDS	ROOF DRAINAGE PLAN	8 / 14	1:100	, <i>1</i> 14414 !	Lemb

COVERINGS LEGEND

NO COVERING

COVER GRADE CONCRETE

CARPET

LAMINATE

TILE (STANDARD WET AREAS)

TILE (UPGRADED AREAS)

DECKING



SUBJECT TO NCC 2022 (1 MAY 2023)

WATERPROOFING & PLUMBING

SIGNATURE: DATE: SIGNATURE: DATE: PLEASE NOTE THAT VARIATIONS WILL NOT BE ACCEPTED	PLAN ACCEPTA	NCE BY OWNER
	SIGNATURE:	DATE:
PLEASE NOTE THAT VARIATIONS WILL NOT BE ACCEPTED	SIGNATURE:	DATE:
AFTER THIS PLAN ACCEPTANCE HAS BEEN SIGNED		


© 2025 WILSON HOMES PTY LTD (ABN 96 126 636 897). THIS DRAWING IS AN ORIGINAL ARTISTIC WORK WITHIN THE MEANING OF THE COPYRIGHT ACT 1968 (CTH). WILSON HOMES PTY LTD IS THE OWNER OF COPYRIGHT IN THIS DRAWING. YOU HEREBY AGREE AND UNDERTAKE THAT YOU WILL NOT




IN ANY WAY REPRODUCE, COPY, MODIFY, USE OR TAKE ADVANTAGE OF THE DRAWING TO BUILD A HOUSE BASED ON THIS PLAN (WHETHER IN WHOLE OR IN PART) WITHOUT THE PRIOR WRITTEN CONSENT OF WILSON HOMES PTY LTD.									₽			
CIFICATION:		REVISION	\top	DRAWN CLIENT:			HOUSE DESIGN:			HOUSE CODE:	DO NOT SCALE DRAWINGS, USE FIGURED DIMENSIONS ONLY. CHECK	1
SCOVERY		1 DRAFT SALES PLAN - CT1	M'	LG 25/08/2025 WILSON COMPLE	£TE		YORK 14			H-WDCYOR10SA	AND VERIFY DIMENSIONS AND LEVELS PRIOR TO THE	1.04
PYRIGHT:		2 PLANS UPDATE		G 28/08/2025 ADDRESS:			FACADE DESIGN:				COMMENCEMENT OF ANY WORK. ALL	
2025		3 PRELIM PLANS - INITILAL ISSUE	Th.	NG 09/09/2025 6 MONTEITH CR, B	BAGDAD TAS 7030		VERVE			F-WDCYOR10VERVA	DISCREPANCIES TO BE REPORTED TO THE DRAFTING OFFICE.	/ersic
				LOT / SECTION / CT:	COUNCIL:		SHEET TITLE:		SHEET No.:	SCALES:	71111	late \
			\top	42 / - / 185527	SOUTHERN MIDLANDS		FLOOR COVERINGS		9 / 14	1:100	714414	emb


2.4041 File Location: D:Tuyen\JOBS\714414 - Wilson Complete - 6 Monteith Crescent, Bagdad - Lot 42\MiTek Issued\714414 Wilson


ELEVATION A SCALE: 1:50

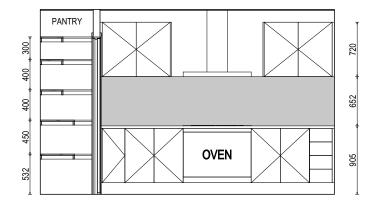


ELEVATION B SCALE: 1:50

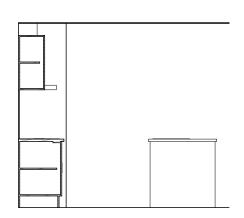


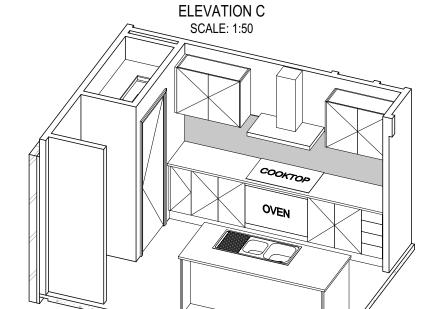

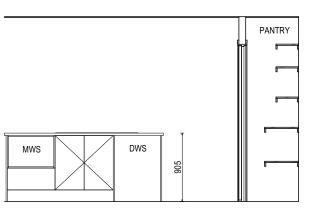

ELEVATION D SCALE: 1:50

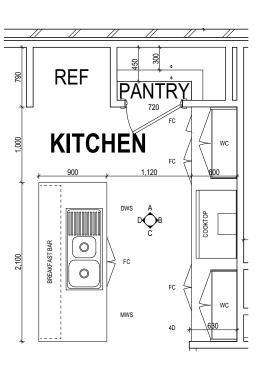

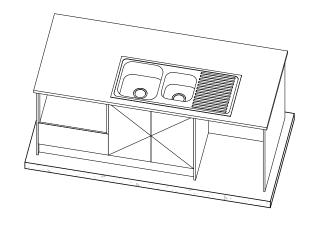

ALL DIMENSIONS ARE FRAME DIMENSIONS

© 2025 WILSON HOMES PTY LTD (ABN 96 126 636 897). THIS DRAWING IS AN ORIGINAL ARTISTIC WORK WITHIN THE MEANING OF THE COPYRIGHT ACT 1968 (CTH). WILSON HOMES PTY LTD IS THE OWNER OF COPYRIGHT IN THIS DRAWING. YOU HEREBY AGREE AND UNDERTAKE THAT YOU WILL NOT IN ANY WAY REPRODUCE, COPY, MODIFY, USE OR TAKE ADVANTAGE OF THE DRAWING TO BUILD A HOUSE BASED ON THIS PLAN (WHETHER IN WHOLE OR IN PART) WITHOUT THE PRIOR WRITTEN CONSENT OF WILSON HOMES PTY LTD.

PLEASE NOTE THAT VARIATIONS WILL NOT BE ACCEPTED AFTER THIS PLAN ACCEPTANCE HAS BEEN SIGNED

HOUSE CODE H-WDCYOR10SA FACADE CODE: F-WDCYOR10VERVA

SIGNATURE:

SIGNATURE:

DRAWN DO NOT SCALE DRAWINGS, USE FIGURED DIMENSIONS ONLY. CHECK REVISION DISCOVERY MLG 25/08/2025 WILSON COMPLETE YORK 14 DRAFT SALES PLAN - CT1 AND VERIFY DIMENSIONS AND LEVELS PRIOR TO THE MLG 28/08/2025 ADDRESS: FACADE DESIGN: COMMENCEMENT OF ANY WORK. AL DISCREPANCIES TO BE REPORTED TO THE DRAFTING OFFICE. 2 PLANS UPDATE © 2025 VERVE TNG 09/09/2025 6 MONTEITH CR, BAGDAD TAS 7030 3 PRELIM PLANS - INITILAL ISSUE LOT / SECTION / CT: SHEET TITLE: SHEET No.: SCALES: 714414 SOUTHERN MIDLANDS KITCHEN DETAILS 10 / 14 | 1:50 42 / - / 185527

REFER TO SHEET 1 (COVER SHEET) FOR ALL BUILDING INFORMATION REGARDING:

SUSTAINABILITY REQUIREMENTS SITE CLASSIFICATION

GENERAL BUILDING INFORMATION DETAILS DEPICTED ON THIS SHEET ARE A REPRESENTATION ONLY. JOINER MAY

ADJUST CABINETRY AS REQUIRED.

DATE:

DATE:

VANITY DETAILS G-VANI-001
WINDOW OVER BATH HOB D-WIND-ALU001 STANDARD BATH HOB D-WETA-BATH003
WET AREA TILING LAYOUTS D-WETA-TILE002 SQUARE SET WINDOWS G-WIND-SSET02 FULL HEIGHT TILING D-LINI-WETA

REFER TO SHEET 1 (COVER SHEET) FOR ALL BUILDING INFORMATION REGARDING: SUSTAINABILITY REQUIREMENTS SITE CLASSIFICATION GENERAL BUILDING INFORMATION

LEGEND

ELBW

HT

CT

HS

WS

SC

TRH

TH

RH

SHLF SHELF SR

DETAILS DEPICTED ON THIS SHEET ARE A REPRESENTATION ONLY

RSHR RAIL SHOWER

ROSE SHOWER ROSE SHOWER ELBOW

CONNECTION MIX MIXER TAP

HOT TAP

COLD TAP

HOB SPOUT

WALL SPOUT

STOP COCK

TR-S TOWEL RAIL - SINGLE TR-D TOWEL RAIL - DOUBLE TL TOWEL LADDER


TOWEL HOLDER TR TOWEL RACK

TMB TUMBLER HOLDER RNG TOWEL RING


ROBE HOOK

SHAMPOO RECESS SOAP SOAP HOLDER


TOILET ROLL HOLDER

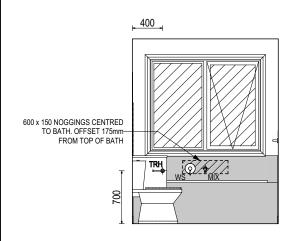

ELEVATION A SCALE: 1:50

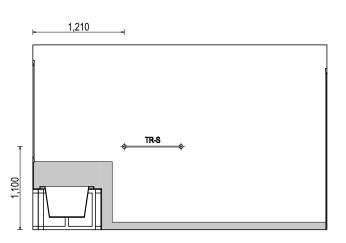

ELEVATION B SCALE: 1:50

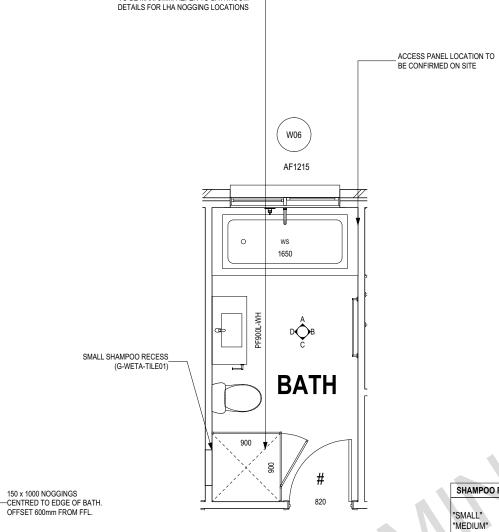

THRESHOLD OF ACCESSIBLE SHOWER ENTRY TO BE MAX. 5MM. REFER TO BATHROOM-


BATHROOM PLAN SCALE: 1:50

			RAL DIMENSIONS
		WIDTH	HEIGHT
"SMALL"	470 x 380mm	548mm	446mm
"MEDIUM"	800 x 380mm	878mm	446mm
"LARGE"	1500 x 380mm	1578mm	446mm

SUBJECT TO NCC 2022

(1 MAY 2023) WATERPROOFING & PLUMBING

PLAN ACCEPTA	ANCE BY OWNER
SIGNATURE:	DATE:
SIGNATURE:	DATE:
PLEASE NOTE THAT VARIAT	IONS WILL NOT BE ACCEPTED
AETED THIS DLAN ACCE	DTANCE HAS BEEN SIGNED

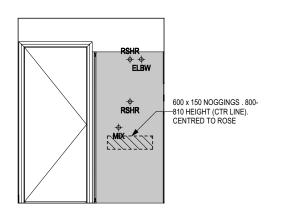

ELEVATION C SCALE: 1:50

ELEVATION D SCALE: 1:50

SR

600 x 150 NOGGINGS . 800-810 HEIGHT (CTR LINE). OFFSET 250mm FROM WALL

ALL DIMENSIONS ARE FRAME DIMENSIONS

© 2025 WILSON HOMES PTY LTD (ABN 96 126 636 897). THIS DRAWING IS AN ORIGINAL ARTISTIC WORK WITHIN THE MEANING OF THE COPYRIGHT ACT 1968 (CTH). WILSON HOMES PTY LTD IS THE OWNER OF COPYRIGHT IN THIS DRAWING. YOU HEREBY AGREE AND UNDERTAKE THAT YOU WILL NOT

WILSON	c
HOMES	(0


	IN ANY WAY REPRODUCE, COPT, WOULT, USE OR TAKE ADVANTAGE OF THE DRAWING TO BOILD A HOUSE DASED ON THIS FLAN (WHETHER IN WHOLE OR IN FACT) WITHOUT THE FROM WRITTEN CONSENT OF WILSON HOWES FIT LID.									iΞ
	SPECIFICATION:	REVISION		CLIENT:		HOUSE DESIGN:		HOUSE CODE:	DO NOT SCALE DRAWINGS, USE FIGURED DIMENSIONS ONLY. CHECK	1
	DISCOVERY	Y 1 DRAFT SALES PLAN - CT1 MLG		WILSON COMPLETE		YORK 14		H-WDCYOR10SA	AND VERIFY DIMENSIONS AND LEVELS PRIOR TO THE	1.04
П	COPYRIGHT:	2 PLANS UPDATE	MLG 28/08/2025			FACADE DESIGN:		FACADE CODE:	COMMENCEMENT OF ANY WORK. ALI	
	© 2025	3 PRELIM PLANS - INITILAL ISSUE	TNG 09/09/2025	6 MONTEITH CR, BAGDA	AD TAS 7030	VERVE		F-WDCYOR10VERVA	DISCREPANCIES TO BE REPORTED TO THE DRAFTING OFFICE.	Version
					COUNCIL:	SHEET TITLE:	SHEET No.:		714414	late '
				42 / - / 185527	SOUTHERN MIDLANDS	BATHROOM DETAILS	11 / 14	1:50	1 144 14	Temp

REFER TO THE FOLLOWING DETAILS: VANITY DETAILS G-VANI-001 WINDOW OVER BATH HOB D-WIND-ALU001 WINDOW OVER BATH HOB D-WIND-ALU001 STANDARD BATH HOB D-WETA-BATH003 WET AREA TILING LAYOUTS D-WETA-TILE002 SQUARE SET WINDOWS G-WIND-SSET02 FULL HEIGHT TILING D-LINI-WETA REFER TO SHEET 1 (COVER SHEET) FOR ALL BUILDING INFORMATION REGARDING:
- SUSTAINABILITY REQUIREMENTS SITE CLASSIFICATION
GENERAL BUILDING INFORMATION


DETAILS DEPICTED ON THIS SHEET ARE A REPRESENTATION ONLY

RSHR RAIL SHOWER


LEGEND

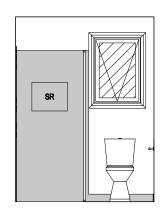


ELEVATION A SCALE: 1:50

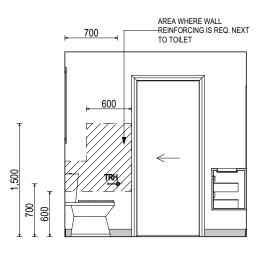


ELEVATION B SCALE: 1:50

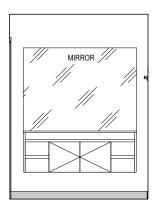

ELEVATION C SCALE: 1:50

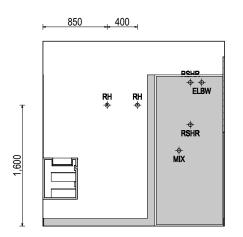

ELEVATION D SCALE: 1:50

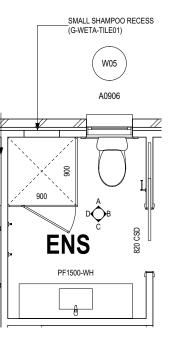

ENSUITE PLAN SCALE: 1:50

ROSE	SHOWER ROSE
ELBW	SHOWER ELBOW CONNECTION
MIX	MIXER TAP
HT	HOT TAP
CT	COLD TAP
HS	HOB SPOUT
WS	WALL SPOUT
SC	STOP COCK
TRH	TOILET ROLL HOLDER
TR-S	TOWEL RAIL - SINGLE
TR-D	TOWEL RAIL - DOUBLE
TL	TOWEL LADDER
TH	TOWEL HOLDER
TR	TOWEL RACK
TMB	TUMBLER HOLDER
RNG	TOWEL RING
RH	ROBE HOOK
SHLF	SHELF
SR	SHAMPOO RECESS
SOAP	SOAP HOLDER

SHAMPOO RECESS SIZE			STRUCTURAL DIMENSIONS			
"SMALL" 470 x 380mm			WIDTH 548mm 878mm 1578mm	HEIGHT 446mm 446mm 446mm		
REFER WILSON HOMES' DETAIL G-WETA-TILE01 FOR FURTHER DETAIL PRIOR TO INSTALLATION.						

SUBJECT TO NCC 2022 (1 MAY 2023) WATERPROOFING & PLUMBING

PLAN ACCEPTANCE BY OWNER						
SIGNATURE:	DATE:					
SIGNATURE:	DATE:					
PLEASE NOTE THAT VARIAT	TIONS WILL NOT BE ACCEPTED					

ALL DIMENSIONS ARE FRAME DIMENSIONS


© 2025 WILSON HOMES PTY LTD (ABN 96 126 636 897). THIS DRAWING IS AN ORIGINAL ARTISTIC WORK WITHIN THE MEANING OF THE COPYRIGHT ACT 1968 (CTH), WILSON HOMES PTY LTD IS THE OWNER OF COPYRIGHT IN THIS DRAWING, YOU HEREBY AGREE AND UNDERTAKE THAT YOU WILL NOT IN ANY WAY REPRODUCE, COPY, MODIFY, USE OR TAKE ADVANTAGE OF THE DRAWING TO BUILD A HOUSE BASED ON THIS PLAN (WHETHER IN WHOLE OR IN PART) WITHOUT THE PRIOR WRITTEN CONSENT OF WILSON HOMES PTY LTD.




INTART WAT ICE ROBOE, OUT, MODILET, OUE OF TAKE ADVANTAGE OF THE DISTANCE DAGED ON THICH EAR (WHETHER WHOLE ON INT ART) WITHOUT THE				TAGE OF THE BIGWING TO BOILD A HOUSE BAGED ON THIS FEAR (WHETHER IN WHOLE OR INT ART) WITHOUT THE FROM WITHER O	MOENT OF WILDOWN TOWNEST IT ETD.	i i i i i i i i i i i i i i i i i i i
	SPECIFICATION:	REVISION	[DRAWN CLIENT:	HOUSE DESIGN: HOUSE CODE: DO NOT SCALE DRAWN	
n	DISCOVERY	1 DRAFT SALES PLAN - CT1	MLG	25/08/2025 WILSON COMPLETE	YORK 14 H-WDCYOR10SA FIGURED DIMENSIONS OF AND VERIFYD DIMENSION OF AND VERIFYD DIMENS	ONS AND 🔀
Ш	COPYRIGHT:			28/08/2025 ADDRESS:	FACADE DESIGN: FACADE CODE: COMMENCEMENT OF ANY	WORK. ALL
	© 2025	3 PRELIM PLANS - INITILAL ISSUE	TNG	09/09/2025 6 MONTEITH CR, BAGDAD TAS 7030	VERVE F-WDCYOR10VERVA DISCREPANCIES TO BE F	
				LOT / SECTION / CT: COUNCIL:	SHEET TITLE: SHEET NO.: SCALES: 71441 ENSUITE DETAILS 12 / 14 1:50 71441	late V
				42 / - / 185527 SOUTHERN MIDLANDS	ENSUITE DETAILS 12 / 14 1:50 / 144	, 4 j

SITE CLASSIFICATION GENERAL BUILDING INFORMATION


DETAILS DEPICTED ON THIS SHEET ARE A REPRESENTATION ONLY PROVIDE ADDITIONAL NOGGING TO LAUNDRY FOR FIXING OF WALL MOUNTED CLOTHES DRYER AS PER D-FRAM-ELEC006

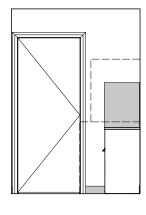


ELEVATION A SCALE: 1:50

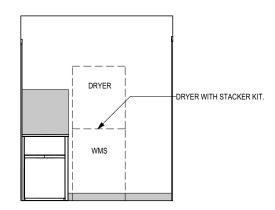


ELEVATION B SCALE: 1:50

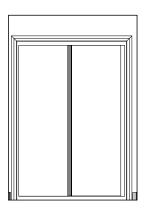

ELEVATION C SCALE: 1:50

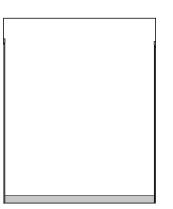

ELEVATION D SCALE: 1:50

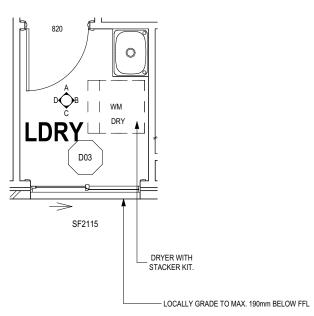

LAUNDRY PLAN SCALE: 1:50

SUBJECT TO NCC 2022 (1 MAY 2023) WATERPROOFING & PLUMBING

PLAN ACCEPTANCE BY OWNER SIGNATURE: DATE: SIGNATURE: DATE: PLEASE NOTE THAT VARIATIONS WILL NOT BE ACCEPTED

AFTER THIS PLAN ACCEPTANCE HAS BEEN SIGNED

ALL DIMENSIONS ARE FRAME DIMENSIONS


© 2025 WILSON HOMES PTY LTD (ABN 96 126 636 897). THIS DRAWING IS AN ORIGINAL ARTISTIC WORK WITHIN THE MEANING OF THE COPYRIGHT ACT 1968 (CTH). WILSON HOMES PTY LTD IS THE OWNER OF COPYRIGHT IN THIS DRAWING. YOU HEREBY AGREE AND UNDERTAKE THAT YOU WILL NOT IN ANY WAY REPRODUCE. COPY MODIEY LISE OR TAKE ADVANTAGE OF THE DRAWING TO BUILD A HOUSE BASED ON THIS PLAN (WHETHER IN WHOLE OR IN PART) WITHOUT THE PRIOR WRITTEN CONSENT OF WILSON HOMES PTY LTD.




INTAKT WAT INCH ROBOUT, OUT THE STAMME TO BOLD AT HOUSE DADED ON THE DISTANT FOR STATE AND AND AN INCH THE STAMME TO BOLD AT HOUSE DADED ON THE FOR THE FOR THE STAMME TO BOLD AT HOUSE DADED ON THE FOR THE STAMME TO BOLD AT HOUSE DADED ON THE STAMME.								证
SPECIFICATION:	REVISION	DRAWN CLIENT:		HOUSE DESIGN:		HOUSE CODE:	DO NOT SCALE DRAWINGS, USE	
DISCOVERY	1 DRAFT SALES PLAN - CT1	MLG 25/08/2025 WILSON COMPLE	TE	YORK 14	YORK 14 FACADE DESIGN:		FIGURED DIMENSIONS ONLY. CHECK AND VERIFY DIMENSIONS AND LEVELS PRIOR TO THE COMMENCEMENT OF ANY WORK, ALL	.041
COPYRIGHT:	2 PLANS UPDATE	MLG 28/08/2025 ADDRESS:						on: 24
© 2025	3 PRELIM PLANS - INITILAL ISSUE	TNG 09/09/2025 6 MONTEITH CR, B	AGDAD TAS 7030	VERVE		F-WDCYOR10VERVA	DISCREPANCIES TO BE REPORTED TO THE DRAFTING OFFICE.	Version
		LOT / SECTION / CT:	COUNCIL:	SHEET TITLE:	SHEET No.:		714414	olate '
		42 / - / 185527	SOUTHERN MIDLANDS	LAUNDRY DETAILS	13 / 14	1:50	114414	Гетр





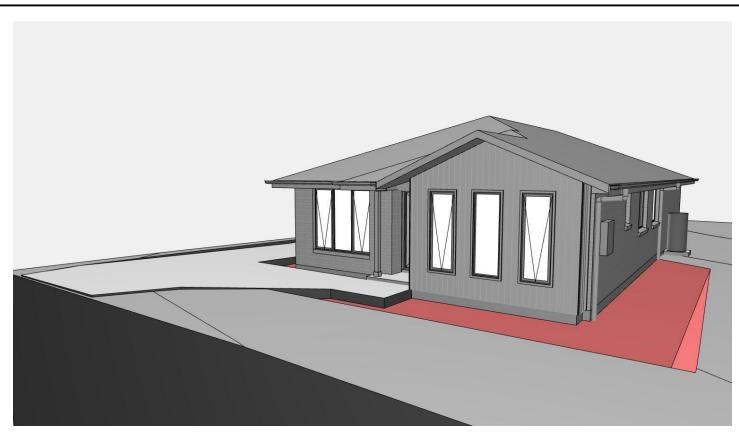

FRONT RIGHT

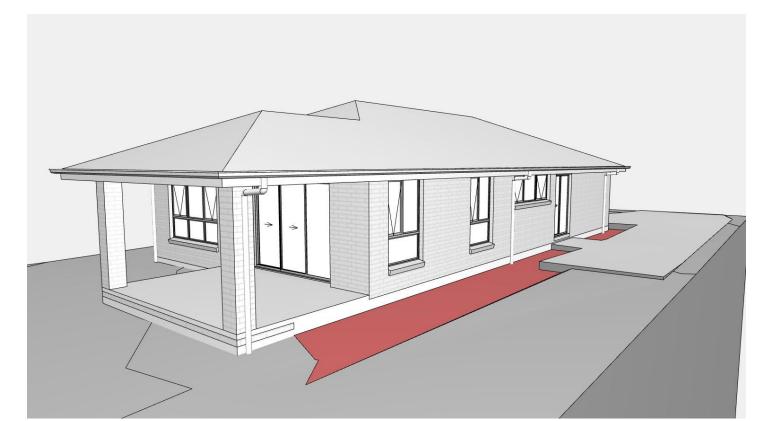

REAR RIGHT REAR LEFT

NOTE: SITE LEVELS AND SETBACKS SHOWN ARE INDICATIVE ONLY AND SUBJECT TO A FINAL CONTOUR SURVEY AND REGISTERED REPORTS BEING COMPLETED. 3D IMAGES ARE FOR ILLUSTRATIVE PURPOSES ONLY AND ARE SUBJECT TO CHANGE.

© 2025 WILSON HOMES PTY LTD (ABN 96 126 636 897). THIS DRAWING IS AN ORIGINAL ARTISTIC WORK WITHIN THE MEANING OF THE COPYRIGHT ACT 1968 (CTH), WILSON HOMES PTY LTD IS THE OWNER OF COPYRIGHT IN THIS DRAWING. YOU HEREBY AGREE AND UNDERTAKE THAT YOU WILL NOT IN ANY WAY REPRODUCE, COPY, MODIFY, USE OR TAKE ADVANTAGE OF THE DRAWING TO BUILD A HOUSE BASED ON THIS PLAN (WHETHER IN WHOLE OR IN PART) WITHOUT THE PRIOR WRITTEN CONSENT OF WILSON HOMES PTY LTD.

SPECIFICATION:		REVISION		
DISCOVERY	1	DRAFT SALES PLAN - CT1	MLG	2
COPYRIGHT:	2	PLANS UPDATE	MLG	2
© 2025	3	PRELIM PLANS - INITILAL ISSUE	TNG	(

DRAWN		CLIENT:							
	25/08/2025	WILSON COMPLETE							
1	28/08/2025	ADDRESS:							
	09/09/2025	MONTEITH CR, BAGDAD TAS 7030							
		LOT / SECTION / CT:	COUNCIL:						
		42 / - / 185527	SOUTHERN MIDLANDS						

HOUSE DESIGN:		HOUSE CODE:	_
YORK 14		H-WDCYOR10SA	F
FACADE DESIGN:		FACADE CODE:	С
VERVE		F-WDCYOR10VERVA	1
SHEET TITLE:	SHEET No.:	SCALES:	Γ
3D VIEWS	14 / 14		i

DO NOT SCALE DRAWINGS, USE FIGURED DIMENSIONS ONLY. CHECK AND VERIFY DIMENSIONS AND LEVELS PRIOR TO THE COMMENCEMENT OF ANY WORK, ALL DISCREPANCIES TO BE REPORTED TO THE DRAFTING OFFICE. 714414



AS2870:2011 SITE ASSESSMENT

6 Monteith Crescent

Bagdad

July 2025

Wilson Homes Reference: 714414



Disclaimer: The author does not warrant the information contained in this document is free from errors or omissions. The author shall not in any way be liable for any loss, damage or injury suffered by the User consequent upon, or incidental to, the existence of errors in the information.



Investigation Details

Client: Wilson Homes- Multi Res Division

Site Address: 6 Monteith Crescent, Bagdad

Date of Inspection: 16/07/2025

Proposed Works: New house

Investigation Method: Geoprobe 540UD - Direct Push

Inspected by: C. Cooper

Site Details

Certificate of Title (CT): 185527/42

Title Area: Approx. 613.6 m²

Applicable Planning Overlays: No planning scheme overlays identified

Slope & Aspect: 1° S facing slope

Vegetation: Grass & Weeds

Background Information

Geology Map: MRT

Geological Unit: Quaternary Sediments

Climate: Annual rainfall 450mm

Water Connection: Mains

Sewer Connection: Serviced-Mains

Testing and Classification: AS2870:2011, AS1726:2017 & AS4055:2021



Investigation

A number of bore holes were completed to identify the distribution and variation of the soil materials at the site, bore hole locations are indicated on the site plan. See soil profile conditions presented below. Tests were conducted across the site to obtain bearing capacities of the material at the time of this investigation.

Soil Profile Summary

BH 1 Depth (m)	BH 2 Depth (m)	USCS	Description
0.00-0.20	0.00-0.20	SM	Silty SAND : dark grey, brown, slightly moist, medium dense
0.20-0.80	0.20-0.70	СН	Silty CLAY : high plasticity, grey, brown, slightly moist, stiff
0.80-1.10	0.70-1.10	CL	Sandy CLAY: medium plasticity, brown, slightly moist, stiff
	1.10-1.30	SC	Clayey SAND: pale grey, slightly moist very dense,
1.10-1.70	1.30-1.60	СН	Silty CLAY : trace of gravel, high plasticity, brown, slightly moist, stiff,
1.70	1.60-1.80	GC	Clayey GRAVEL: pale yellow, slightly moist, stiff, refusal on rock/boulder.

Site Notes

Soils on the site are developing from quaternary sediments, the clay fraction is likely to show moderate ground surface movement with moisture fluctuations.

Site Classification

The site has been assessed and classified in accordance with AS2870:2011 "Residential Slabs and Footings".

The site has been classified as:

Class M

*y*_s range: **20-40mm**

Notes: that is a moderately reactive clay.



Wind Loading Classification

According to "AS4055:2021 - Wind Loads for Housing" the house site is classified below:

Wind Classification:	N2
Region:	Α
Terrain Category:	2.5
Shielding Classification:	PS
Topographic Classification:	T0
Wind Classification:	N2
Design Wind Gust Speed – m/s (V _{h,u}):	40

Construction Notes & Recommendations

The site has been classified as **Class M** - Moderately reactive clay or silt site, which may experience moderate ground movement from moisture changes.

It is recommended that all footings be founded in the natural material with bearing capacities >100kPa.

All earthworks on site must comply with AS3798:2007, and I further recommend that consideration be given to drainage and sediment control on site during and after construction. Care should also be taken to ensure there is adequate drainage in the construction area to avoid the potential for weak bearing and foundation settlement associated with excessive soil moisture.

I also recommend that during construction that I and/or the design engineer be notified of any major variation to the foundation conditions as predicted in this report.

Dr John Paul Cumming B.Agr.Sc (hons) PhD CPSS GAICD

Director



Explanatory Notes

1 Scope of Works

The methods of description and classification of soils used in this report are based largely on Australian Standard 1726 – Geotechnical Site Investigations (AS1726:2017), with reference to Australian Standard 1289 – Methods for testing soils for engineering purposes (AS1289), for eventual Site Classification according to Australian Standard 2870 (AS2870:2011) – Residential Slabs and Footings and Australian Standard 1547 (AS1547:2012) On-site domestic wastewater management.

1.1 Site Classification AS2870:2011

Site classification with reference to the above Australian Standards are based on site reactivity.

Class	Foundation Conditions	Characteristic Surface Movement
Α	Most sand and rock sites with little or no ground movement from moisture changes.	0mm
S	Slightly reactive clay sites, which may experience only slight ground movement from moisture changes.	0 – 20mm
М	Moderately reactive clay or silt sites, which may experience moderate ground movement from moisture changes.	20 – 40mm
H-1	Highly reactive clay sites, which may experience high ground movement from moisture changes.	40 – 60mm
H-2	Highly reactive clay sites, which may experience very high ground movement from moisture changes.	60 – 75mm
E	Extremely reactive sites, which may experience extreme ground movement from moisture changes.	>75mm

Note: Soils where foundation performance may be significantly affected by factors other than reactive soil movement are classified as **Class P**.

A site is classified as Class P when:

- The bearing capacity of the soil profile in the foundation zone is generally less than 100kpa
- If excessive foundation settlement may occur due to loading on the foundation.
- The site contains uncontrolled fill greater than 0.8m in depth for sandy sites and 0.4m in depth for other soil materials.
- The site is subject to mine subsistence, landslip, collapse activity or coastal erosion.
- The site is underlain by highly dispersive soils with significant potential forerosion
- If the site is subject to abnormal moisture conditions which can affect foundation performance



2 Soil Characterisation

This information explains the terms of phrase used within the soil description area of the report.

It includes terminology for cohesive and non-cohesive soils and includes information on how the Unified Soil Classification Scheme (USCS) codes are determined.

NON COHSIVE - SAND & GRAVEL						
Consistency Description	Field Test	Dynamic Cone Penetrometer blows/100 mm				
Very loose (VL)	Easily penetrated with 13 mm reinforcing rod pushed by hand.	0 - 1				
Loose (L)	Easily penetrated with 13 mm reinforcing rod pushed by hand. Can be excavated with a spade; 50 mm wooden peg can be easily driven.	1 - 3				
Medium dense (MD)	Penetrated 300 mm with 13 mm reinforcing rod driven with 2 kg hammer, - hard shovelling.	3 - 8				
Dense (D)	Penetrated 300 mm with 13 mm reinforcing rod driven with 2 kg hammer, requires pick for excavation: 50 mm wooden peg hard to drive.	8 - 15				
Very dense (VD)	Penetrated only 25 - 50 mm with 13 mm reinforcing rod driven with 2 kg hammer.	>15				

COHESIVE - SILT & CLAY						
Consistency Description	Field Test	Indicative undrained shear strength kPa				
Very soft	Easily penetrated >40 mm by thumb. Exudes between thumb and fingers when squeezed in hand.	<12				
Soft	Easily penetrated 10 mm by thumb. Moulded by light finger pressure	>12 and <25				
Firm	Impression by thumb with moderate effort. Moulded by strong finger pressure	>25 and <50				
Stiff	Slight impression by thumb cannot be moulded with finger.	>50 and <100				
	Very tough. Readily indented by thumbnail.					
Very Stiff		>100 and <200				
	Brittle. Indented with difficulty by thumbnail.					
Hard		>200				





USCS Material Descriptions

Soils for engineering purposes are the unconsolidated materials above bedrock, they can be residual, alluvial, colluvial or aeolian in origin.

Major Divisions		Particle size mm Symbol		Typical Names	Laboratory Classification					
	BOULDERS	200		36).075 mm (2)	Plasticity of fine fraction	$C_{tt} = \frac{D_{t0}}{D_{t0}}$	$C_i = \frac{(D_{si})^i}{(D_{si})(D_{si})}$	NOTES
(mm)	COBBLES	200								
tian 0.075 r	-	63	GW	Well graded gravels and gravel-sand mixtures, little or no fines		0-5	-	>4	Between 1 and 3	(1) Identify fines by the method giver
Sarger	GRAVELS (more than	coarse	GP	Poorly graded gravels and gravel-sand mixtures, little or no fines, uniform gravels	Divisions	0-5	-	Fails to	comply with	for fine-grained soils.
NED SC 63 mm	half of coarse	medium	GM	Silty gravels, gravel-sand-silt mixtures (1)	Major	12-50	Below 'A' line or PI<4	-	-	
COARSE GRAINED SOIL.	fraction is larger than 2.36 mm)	6 fine 2.38	GC	Clayey gravels, gravel-sand- clay mixtures (1)	i given in	12-50	Above 'A' line and PI>7	-	H	(2) Borderline
COARS (more than half of material k	SANDS (more than half of coarse fraction is smaller than 2.36 mm)	coarse	SW	Well graded sands and gravelly sands, little or no fines	file catteda	0-5	2 4 8	>6	Between 1 and 3	classifications occur when the percentage of fines (fraction
			SP	Poorly graded sands and gravelly sands, little or no fines	ording to	0-5	-		comply with	smaller than 0.075 mm size) is greater than 5% and less
		medium 0.2	SM	Silty sands, sand silt mixtures (1)	ins acc	12-50	Below 'A' line or PI<4	-	=	than 12%. Borderline
		fine 0.075	SC	Clayey sands, sand-clay mixtures (1)	n of tractic	12-50	Above 'A' line and PI>7	-	+	classifications require the use of SP-SM, GW- GC.
man 0.075 mm	SILTS & CLAYS (Liquid Limit ≤50%)		ML	Inorganic silts, very fine sands, rock flour, silty or clayey fine sands or clayey silts with slight plasticity	For classification of fine grained soils				ined soils	
smaller			CL	Inorganic clays of low to medium plasticity, gravelly clays, sandy clays, silty clays, lean clays	g 63 mm for	60			fror coarse gr	rained soils.
SOILS mm b			OL	Organic silts and clays of low plasticity	passin	10				100
FINE GRANED SOILS half of malferfal less than 63 mm is		MH Inorganic silts, mic- aceous or diato-maceous fine sands or silts, elastic silts SILTS & CLAYS Liquid Limit >50%) CH Inorganic clays of high plasticity, fat clays	МН	or diato-maceous fine sands	gradation curve of material passing	Plastic Index (%)				Trans Particular
	CONTRACTOR STATE		curve	William V	24	a a	MILE	DE .		
	S.	OF		Organic silts and clays of high plasticity	adation	0	Zem	W.	40.	
(more than ha	HIGHLY ORGANIC SOILS		PT	Peat and other highly organic soils	Use the gr	6	10 20	so 40 Liqu	se es sid Limit (%)	70 M2 96 100



Grain size analysis is performed by two processes depending on particle size. Sand silt and clay particles are assessed using a standardised hydrometer test, and coarse sand and larger is assessed through sieving by USCS certified sieves. For more detail see the following section.

Soil Classification	Particle Size
Clay	Less than 0.002mm
Silt	0.002 – 0.06mm
Fine/Medium Sand	0.06 – 2.0mm
Coarse Sand	2.0mm – 4.75mm
Gravel	4.75mm – 60.00mm

1.4 Bearing Capacities and DCP testing.

DCP and PSP weighted penetrometer tests – Dynamic Cone Penetrometer (DCP) and Perth Sand Penetrometer (PSP) tests are carried out by driving a rod into the ground with a falling weight hammer and measuring the blows for successive 100mm increments of penetration. Normally, there is a depth limitation of 1.2m but this may be extended in certain conditions by the use of extension rods. The methods for the two tests are quite similar.


- Dynamic Cone Penetrometer a 16mm rod with a 20mm diameter cone end is driven with a 9kg hammer dropping 510mm (AS 1289, Test 6.3.2).
- Perth Sand Penetrometer a 16mm diameter flat-ended rod is driven with a 9kg hammer, dropping 600mm (AS 1289 Test 6.3.3). This test was developed for testing the density of sands and is mainly used in granular soils and filling.

Site Anomalies – During construction GES will need to be notified of any major variation to the foundation conditions as predicted in this report.





1.5 Batter Angles for Embankments (Guide Only)

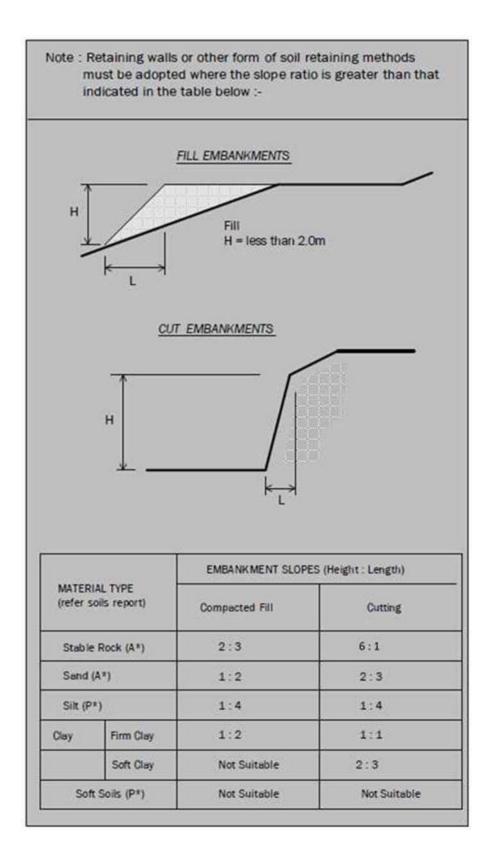



Disclaimer

This Report has been prepared in accordance with the scope of services between Geo-Environmental Solutions Pty. Ltd. (GES) and the Client. To the best of GES's knowledge, the information presented herein represents the client's requirements at the time of printing of the Report. However, the passage of time, manifestation of latent conditions or impacts of future events may result in findings differing from that discussed in this Report. In preparing this Report, GES has relied upon data, surveys, analyses, designs, plans and other information provided by the Client and other individuals and organisations referenced herein. Except as otherwise stated in this Report, GES has not verified the accuracy or completeness of such data, surveys, analyses, designs, plans and other information.

The scope of this study does not allow for the review of every possible geotechnical parameter or the soil conditions over the whole area of the site. Soil and rock samples collected from the investigation area are assumed to be representative of the areas from where they were collected and not indicative of the entire site. The conclusions discussed within this report are based on observations and/or testing at these investigation points.

This report does not purport to provide legal advice. Readers of the report should engage professional legal practitioners for this purpose as required.

No responsibility is accepted for use of any part of this report in any other context or for any other purpose by a third party.



Bearing Capacity – Maximum bearing pressure that can be sustained by the foundation from the proposed footing system under service loads which should avoid failure or excessive settlement.

Clay – (Mineral particles less than 0.002mm in diameter). Fine grained cohesive soil with plastic properties when wet. Also includes sandy clays, silty clays, and gravelly clays.

Dynamic Cone Penetrometer (DCP) – Field equipment used to determine underlying soil strength and therefore bearing capacity (kPa) by measuring the penetration of the device into the soil after each hammer blow.

Dispersive soil – A soil that has the ability to pass rapidly into suspension in water.

Footing – Construction which transfers the load from the building to the foundation.

Foundation – Ground which supports the building

Landslip – Foundation condition on a sloping site where downhill foundation movement or failure is a design consideration.

Qualified Engineer – A professional engineer with academic qualifications in geotechnical or structural engineering who also has extensive experience in the design of the footing systems for houses or similar structures.

Reactive Site – Site consisting of clay soil which swells on wetting and shrinks on drying by an amount that can damage buildings on light strip footings or unstiffened slabs. Includes sites classified as S, M, H-1, H-2 & E in accordance with AS2870-2011.

Sand – (Mineral particles greater than 0.02mm in diameter). Granular non-cohesive, non-plastic soil that may contain fines including silt or clay up to 15%.

Services – Means all underground services to the site including but not limited to power, telephone, sewerage, water & storm water.


Silt – (Mineral particles 0.002 - 0.02mm in diameter). Fine grained non-cohesive soil, non-plastic when wet. Often confers a silky smoothness of field texture, regularly includes clay and sand to form clayey silts, sandy silts and gravelly silts.

Site – The site title, as denoted by address, lot number, or Certificate of Title (CT) number, or Property Identification Number (PID).

Surface Movement (Ys) – Design movement (mm) at the surface of a reactive site caused by moisture changes.





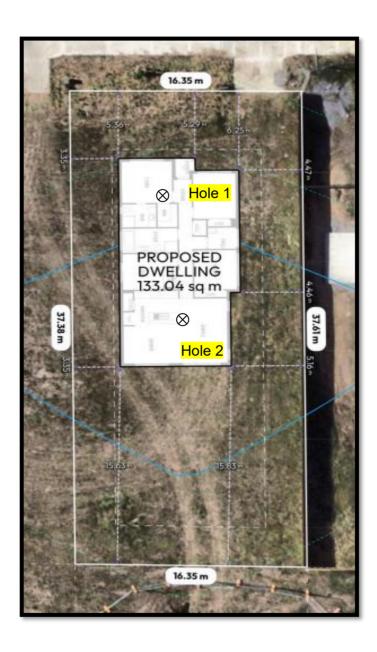





APPENDIX 1 - DCP Results Table

Dynamic Cone Penetration (DCP) Conversion to Californian Bearing Ratio (ref: Australian Standard AS 1289.6.3.2 - 1997)

DCP Location BH1

Depth (mm)	DCP	DCP	DCP Resistance	Allowable Bearing Capacity	CBR (Rounded Up)
	(Blows/100mm)	(mm/Blow)	(mPa)	(kPa)	
0-100 100-200	6 8	16.7 12.5	1.9 2.5	208 278	13 17
200-300	8	12.5	2.5	278	17
300-400	6	16.7	1.9	208	13
400-500	6	16.7	1.9	208	13
500-600	6	16.7	1.9	208	13
600-700	4	25.0	1.3	139	8
700-800	6	16.7	1.9	208	13
800-900	7	14.3	2.2	243	15
900-1000	11	9.1	3.4	382	25
1000-1100	13	7.7	4.1	451	30
1100-1200	11	9.1	3.4	382	25
1200-1300	11	9.1	3.4	382	25
1300-1400	12	8.3	3.8	417	27
1400-1500	15	6.7	4.7	521	35
1500-1600	20	5.0	6.3	694	48



Appendix 2 – Site Photos







CERTIFICATE OF QUALIFIED PERSON – ASSESSABLE ITEM

Section 321

To:	Wilson Homes- Multi Res Divi		Owner /Agent		FF			
	250 Murray Street			Address	Forn	55		
	Hobart 7000			Suburb/postcode				
Qualified perso	Qualified person details:							
Qualified person:	John-Paul Cumming							
Address:	29 Kirksway Place	Phone No:	03	6223 1839				
	Battery Point	Fax No:						
Licence No:	AO999 Email address		004 ımming	j@geosolutic	ns.ne	t.au		
Qualifications and Insurance details:	ns and Certified Professional Soil (description of the control of				cription from Column 3 of the ctor's Determination - Certificates valified Persons for Assessable s			
Speciality area of expertise:	expertise: AS2070-20111 Outlidation				cription from Column 4 of the ctor's Determination - Certificates ualified Persons for Assessable s)			
Details of work	1							
Address:	6 Monteith Crescent			Lot No:				
	Bagdad		030	Certificate of	title No:	185527/4 2		
The assessable item related to this certificate:	Classification of foundation Conditions according to AS2870-2011			(description of the assessable item being certified) Assessable item includes – - a material; - a design - a form of construction - a document - testing of a component, building system or plumbing system - an inspection, or assessment, performed				
Certificate details:								
Certificate type: Foundation Classification (description from Column 1 of Schedule 1 of the Director's Determination - Certificates by Qualified Persons for Assessable Items n)								
This certificate is in relation to the above assessable item, at any stage, as part of - (tick one)								
building work, plumbing work or plumbing installation or demolition work or								
a building, temporary structure or plumbing installation: □								



In issuing this certificate the following matters are relevant –

Documents: The attached soil report for the address detailed above in 'details of

work'

Relevant

calculations:

Reference the above report.

References: AS2870:2011 residential slabs and footings

AS1726:2017 Geotechnical site investigations

CSIRO Building technology file - 18.

Substance of Certificate: (what it is that is being certified)

Site Classification consistent with AS2870-2011.

Scope and/or Limitations

The classification applies to the site as inspected and does not account for future alteration to foundation conditions as a result of earth works, drainage condition changes or variations in site maintenance.

I, John-Paul Cumming certify the matters described in this certificate.

Qualified person:

Signed:


Certificate No:

J11917

22/07/2025

Date:



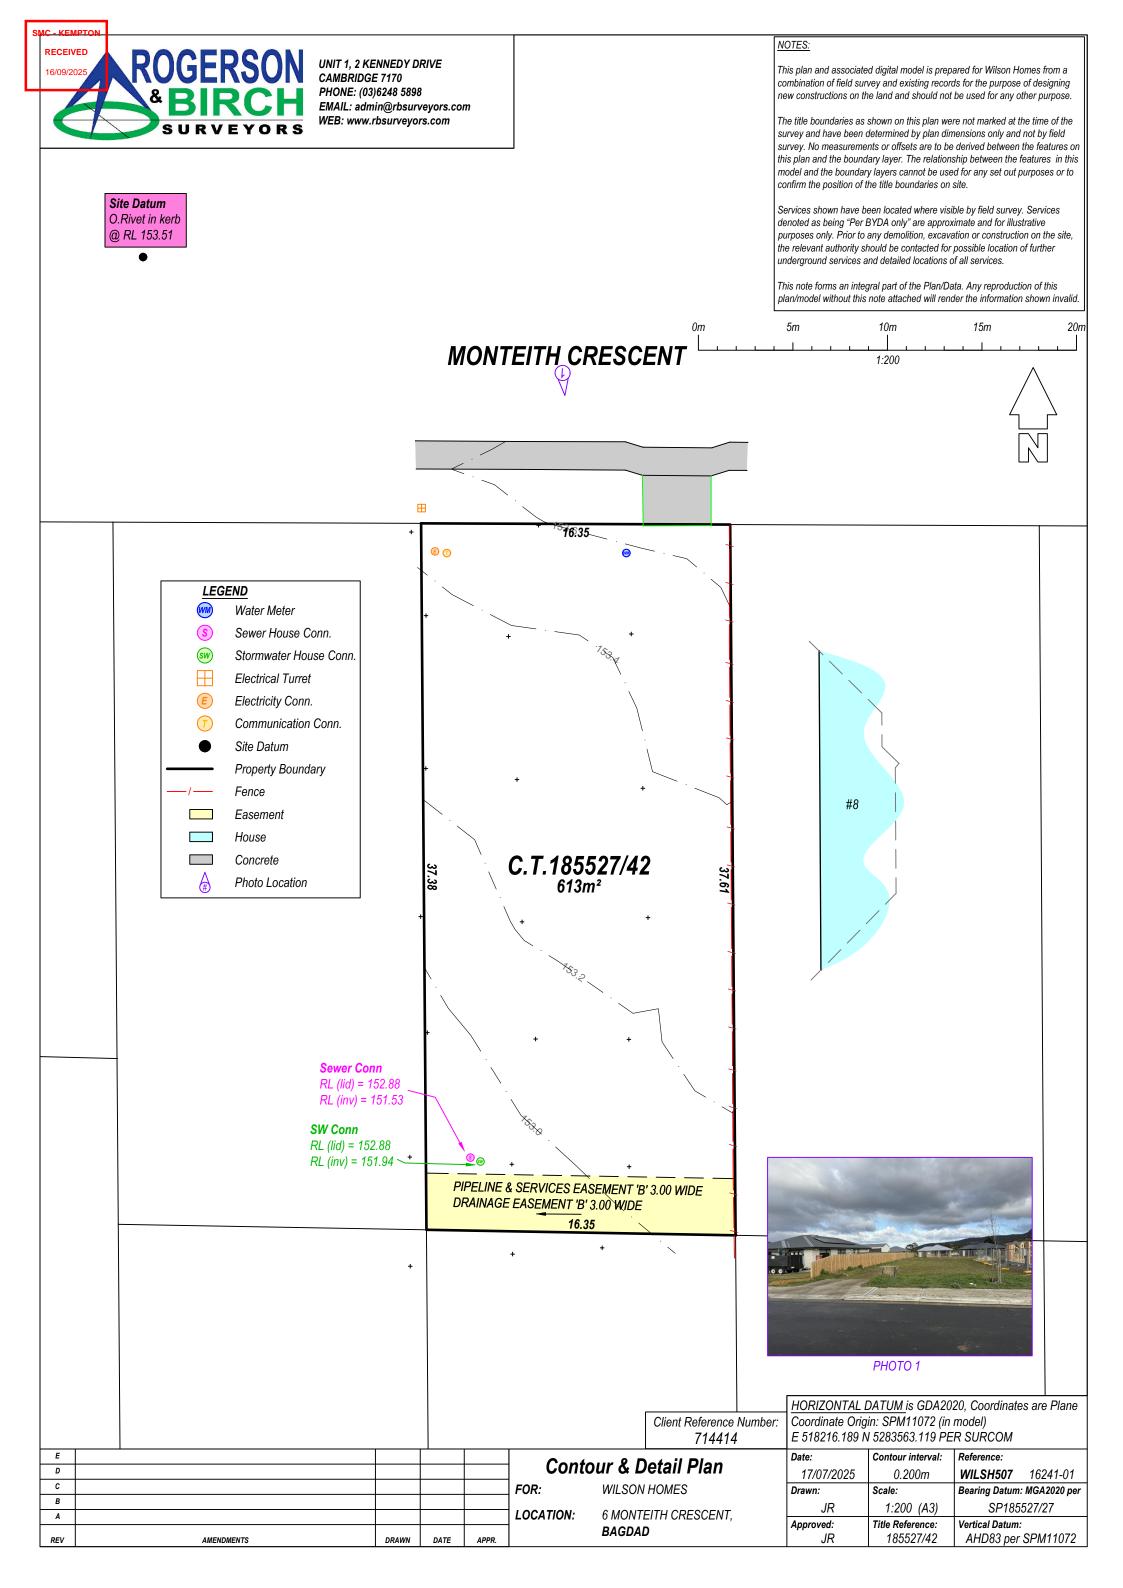

Annexure B - COVENANTS


The owner of each lot on the Plan covenants with the vendor DFY INVESTMENT PTY LTD and the owners for the time being of every other lot shown on the plan to the intent that the burden of these covenant may run with and bind the Covenanters lot and every part thereof and the benefit thereof shall be annexed to and devolve with each, and every part of every other lot shown on the plan to observe the following stipulations:

- 1. Not to erect any building on the lot with outer walls of asbestos cement sheeting;
- 2. Not without prior written consent from the Vendor construct any walls of any building on the lot from any material except, brick, stone, masonry block, or similar material, rendered insulated concrete forms, timber construction, flat metal cladding or insulated boards that are rendered, painted or pre-coloured.
- 3. Not to erect a dwelling without a minimum of 1 single garage under the roof of the dwelling.
- 4. Not to erect any dwelling house or residential building on a lot using any roofing material or with roofs other than tiles or colourbond iron.
- 5. Not to erect any garage or outbuilding on the lot using any roofing material or with roofs other than tiles or colourbond iron.
- 6. Not without prior written consent from the Vendor construct or allow to be constructed any kit home or relocatable dwelling on the lot.
- 7. Not to erect or place or suffer to be or remain on the lot any temporary building structure or caravan, except a shed or workshop that is used for the purpose of and in connection with, and during the construction of a permanent building or buildings on the lot and not otherwise.
- 8. Not to erect on the lot any buildings other than one private dwelling house and the usual out-buildings appurtenant thereto.
- 9. The main building erected on any portion of the lot shall not be used for any other purpose than a private residential house.
- 10. Not to erect or permit to be erected or remain on a lot any hoarding or advertising sign (except any notice or advertisement in the usual for the sale or letting of the lot or any building erected thereon).
- 11. The owner of each lot on the Plan covenants with the Vendor that the vendor will not be required to fence any lot on the Plan.
- 12. Not to erect on the lot any residential buildings of a size less than 125m2 (including an attached garage).
- 13. Not to erect a fence on the lot in any material other than timber paling or colourbond iron or metal in the colour 'Monument'.



RESULT OF SEARCH

RECORDER OF TITLES

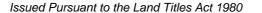



SEARCH OF TORRENS TITLE

VOLUME	FOLIO
185527	42
EDITION 2	DATE OF ISSUE 15-Feb-2025

SEARCH DATE : 04-Jul-2025 SEARCH TIME : 11.31 AM

DESCRIPTION OF LAND

Parish of STRANGFORD Land District of MONMOUTH

Lot 42 on Sealed Plan 185527

Derivation: Part of 60A-1R-34P Gtd. to C.A. Galletly and Anor.

Prior CT 36069/1

SCHEDULE 1

N160287 TRANSFER to WILSON HOMES TASMANIA PTY LTD Registered 15-Feb-2025 at 12.01 PM

SCHEDULE 2

Reservations and conditions in the Crown Grant if any SP185527 EASEMENTS in Schedule of Easements SP185527 COVENANTS in Schedule of Easements SP185527 FENCING COVENANT in Schedule of Easements

UNREGISTERED DEALINGS AND NOTATIONS

No unregistered dealings or other notations




FOLIO PLAN

RECORDER OF TITLES

Tasmanian Government

Issued Pursuant to the Land Titles Act 1980

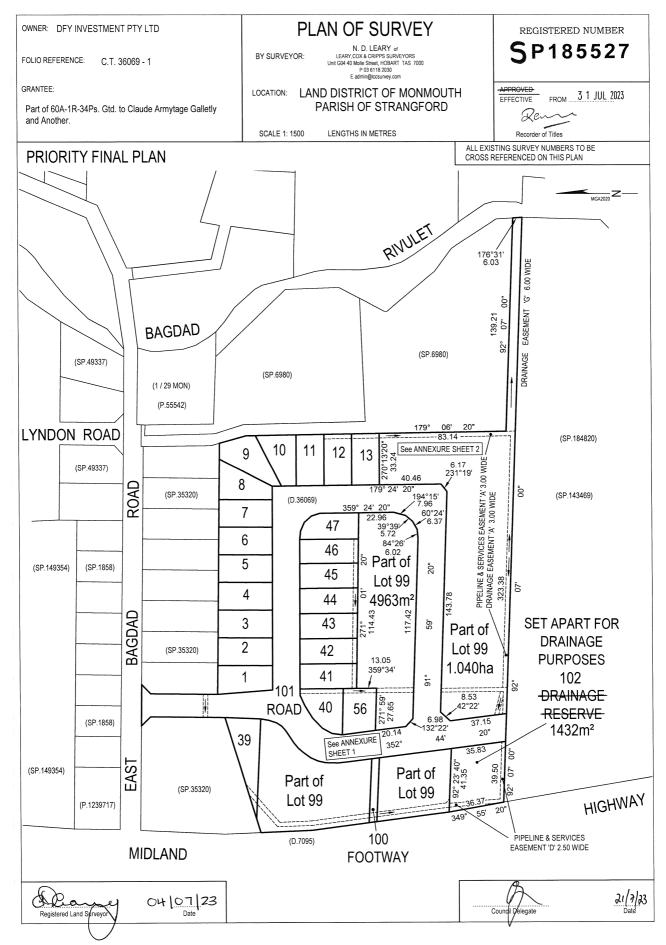




FOLIO PLAN

RECORDER OF TITLES



Issued Pursuant to the Land Titles Act 1980

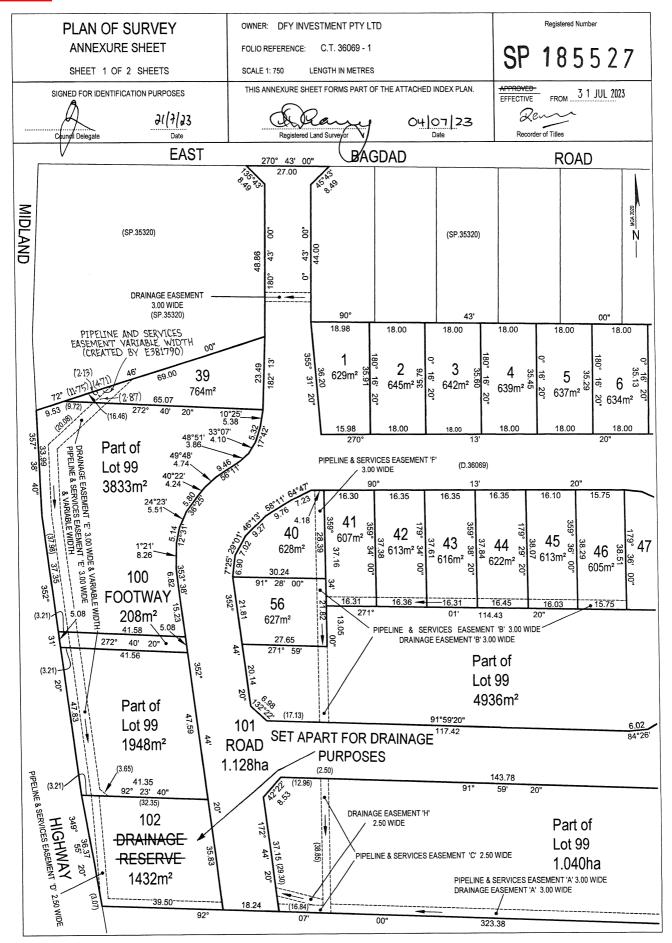




FOLIO PLAN

RECORDER OF TITLES



Issued Pursuant to the Land Titles Act 1980

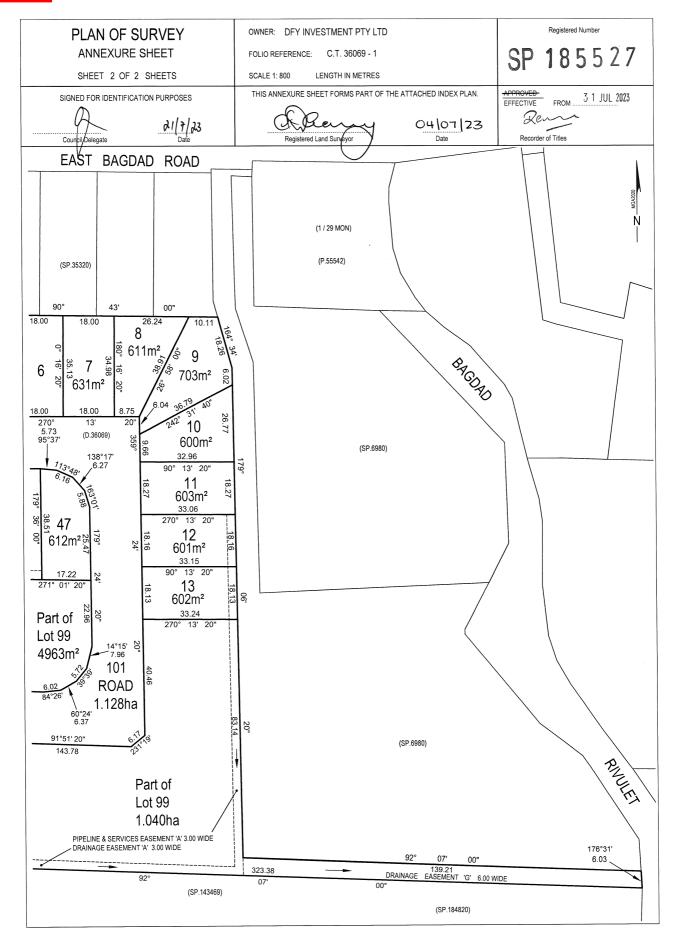

Search Date: 04 Jul 2025 Search Time: 11:31 AM Volume Number: 185527 Revision Number: 03 Page 3 of 3