

Public Notice Details

Planning Application Details

Application No	DA2500128

Property Details

Property Location	25 Monteith Crescent Bagdad
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Application Information

Application Type	Discretionary Development Application
Development Category	Dwelling
Advertising Commencement Date	8/10/25
Advertising Closing Period	22/10/25
If the Council Offices are closed during normal office hours within the above period, the period for making representations is extended.	

Enquiries regarding this Application can be made via to Southern Midlands Council on (03) 6254 5050 or by emailing <u>planningenquires@southernmidlands.tas.gov.au</u>. Please quote the <u>development application number</u> when making your enquiry.

Representations on this application may be made to the General Manager in writing either by

Post: PO Box 21, Oatlands Tas 7120 Email: mail@southernmidlands.tas.gov.au

Fax: 03 6254 5014

All representations must include the authors full name, contact number and postal address and be received by the advertising closing date.





APPLICATION FOR PLANNING PERMIT – USE AND DEVELOPMENT Residential Use

Use this form to apply for planning approval in accordance with section 57 and 58 of the Land Use Planning and Approvals Act 1993

		'					
Applicant / Ow	vner Details	:					
Owner / s Name	Wilson Homes Tasmania Pty Ltd						
	250 Murra	250 Murray Street, Hobart,7000					
Postal Address					Phone No:		
					Fax No:		
Email address:					sonya	a.gadd@v	wilsonhomes.com.au
Applicant Name (if not owner)	Wilson Ho	omes P	TY LTD				
Postal Address:	250 Murra	ay Stree	et		Phone No:	(03) 621	39920
	Hobart			TAS	Fax No:		
Email address:					sonya	a.gadd@v	wilsonhomes.com.au
Description of	proposed u	se and/	or developme	nt:			
Address of new use and development:	25 Monteith Cresce	ent, Bagdad					
Certificate of Title No:	Volume No 1	185527		Lot No:	13		
Description of proposed use or development:	New Building - Dwelling ie: New Dwelling /Additions/ Demolition / /Shed / Farm Building / Carport / Swimming Pool or detail other etc.						
Current use of land and buildings:	Vacant Land Eg. Are there any existing buildings on this title? If yes, what is the main building used as?			ngs on this title? , what is the main building			
Is the property Heritage Listed	Please tick ✓answer Yes		No			1	
Proposed Material	What are the p external wall m		Bricks		What is the propose material	d roof	Colourbond
	What are the p		ТВА		What is the propose	d roof colour	ТВА
	What is the pronew floor area		147.51		What is the estimate all the new work pro		\$368,435.00



Please attach any additional information that may be required by Part 6.1 Application Requirements of the Tasmanian Planning Scheme.

Signed Declaration	

I/we hereby apply for a planning approval to carry out the use or development described in this application and in the accompanying plans and documents, accordingly I declare that:

- 1. The information given is a true and accurate representation of the proposed development. I understand that the information and materials provided with this development application may be made available to the public. I understand that the Council may make such copies of the information and materials as, in its opinion, are necessary to facilitate a thorough consideration of the Development Application. I have obtained the relevant permission of the copyright owner for the communication and reproduction of the plans accompanying the development application, for the purposes of assessment of that application. I indemnify the Southern Midlands Council for any claim or action taken against it in respect of breach of copyright in respect of any of the information or material provided.
- 2. I am the applicant for the planning permit and <u>I have notified the owner/s of the land in writing</u> of the intention to make this application in accordance with Section 52(1) of the *Land Use Planning Approvals Act 1993* (or the land owner has signed this form in the box below in "Land Owner(s) signature);

Applicant Signature	Applicant Name (<i>Please print</i>) Timothy Ribbons	Date 16/09/2025
(If not the Owner)		
Land Owner(s) Signature	Land Owners Name (please print)	Date
Rm	Wilson Homes Tasmania	16/09/2025
Land Owner(s) Signature	Land Owners Name (please print)	Date



RESIDENTIAL DEVELOPMENT - Information & Checklist sheet

Use this check list for submitting your application

Submitting your application ✓

1.	All plans and information required per Application Requirements of the Planning Scheme www.iplan.tas.gov.au ie: site plan showing all existing buildings, proposed buildings, elevation plans etc.			
2.	Copy of the current Certificate of Title, Schedule of Easements and Title Plan (Available from Service Tasmania Offices)			
3.	Any reports, certificates or written statements to accompany the Application (if applicable) required by the relevant zone or code.			
4.	Prescribed fees payable to Council			
Inf	formation			
pro Tra	ou provide an email address in this form then the Southern Midlands Council ("the Council") will treat the ovision of the email address as consent to the Council, pursuant to Section 6 of the Electronic ansactions Act 2000, to using that email address for the purposes of assessing the Application under the nd Use Planning and Approvals Act 1993 ("the Act").			
	ou provide an email address, the Council will not provide hard copy documentation unless specifically quested.			
	s your responsibility to provide the Council with the correct email address and to check your email for nmunications from the Council.			
If you do not wish for the Council to use your email address as the method of contact and for the giving of				
information, please tick ✓ the box				
He	ritage Tasmania			
He	If the Property is listed on the Tasmanian Heritage Register then the Application will be referred to Heritage Tasmania unless an Exemption Certificate has been provided with this Application. (Phone 1300 850 332 (local call cost) or email enquires@heritage.tas.gov.au)			
Та	sWater			
	pending on the works proposed Council may be required to refer the Application to TasWater for sessment (Phone 136992)			

PRIVACY STATEMENT

The Southern Midlands Council abides by the Personal Information Protection Act 2004 and views the protection of your privacy as an integral part of its commitment towards complete accountability and integrity in all its activities and programs.

Collection of Personal Information: The personal information being collected from you for the purposes of the Personal Information Protection Act, 2004 and will be used solely by Council in accordance with its Privacy Policy. Council is collecting this information from you in order to process your application.

Disclosure of Personal Information: Council will take all necessary measures to prevent unauthorised access to or disclosure of your personal information. External organisations to whom this personal information will be disclosed as required under the Building Act 2000. This information will not be disclosed to any other external agencies unless required or authorised by law.

Correction of Personal Information: If you wish to alter any personal information you have supplied to Council please telephone the Southern Midlands Council on (03) 62545050. Please contact the Council's Privacy Officer on (03) 6254 5000 if you have any other enguires concerning Council's privacy procedures.

ADVICE: There is no connection between Planning approval and Building & Plumbing approvals. Owners are to ensure that the work is either Low Risk Building Work, Notifiable Building Work or Permit work in accordance with the Directors Determination – Categories of Building & Demolition Work v 1.4 dated 12 March 2021.

https://www.cbos.tas.gov.au/ data/assets/pdf file/0014/405014/Directors-determination-categories-of-building-and-demolition-work-2021.pdf

TOTAL FLOOR AREAS MAIN DWELLING, GROUND F
MAIN DWELLING, GROUND F

IVI	AIN DWELLING, GROUND FLOOR	
	ALFRESCO	12.00
	LIVING	133.66
	PORCH	1.85
		147.51 m

AS & NCC COMPLIANCE


ALL CONSTRUCTION TO BE IN ACCORDANCE WITH NCC 2022 AND APPLICABLE AUSTRALIAN STANDARDS AT TIME OF APPROVAL

- SLAB IN ACCORDANCE WITH AS 2870. REFER TO ENGINEERS DETAILS FOR ALL SLAB DETAILS. BRICK CONTROL JOINTS PROVIDED IN ACCORDANCE WITH NCC 2022.
- ALL STEEL FRAMING TO BE DESIGNED TO AS 4100-2020 OR AS/NZS INSULATION TO BE INSTALLED IN ACCORDANCE WITH NCC 2022 AND
- ALL APPLICABLE AUSTRALIAN STANDARDS.
- TERMITE PROTECTION IN ACCORDANCE WITH AS 3660 AND NCC 2022. GLAZING IN ACCORDANCE WITH AS 1288 AND NCC 2022. SMOKE ALARMS IN ACCORDANCE WITH AS 3786 AND NCC 2022. INTERNAL WATERPROOFING IN ACCORDANCE WITH NCC 2022
- HOUSING PROVISIONS PART 10.2. EXTERNAL WATERPROOFING IN ACCORDANCE WITH AS 3740 AND AS
- WET AREA FLOORS TO FALL TO FLOOR WASTES AT MIN. 1:80 AND MAX.
- 1:50 GRADE (IF APPLICABLE). CONDENSATION MANAGEMENT IN ACCORDANCE WITH NCC 2019
- BUILDING SEALING IN ACCORDANCE WITH NCC 2022. SERVICES IN ACCORDANCE WITH NCC 2022.
- EARTHWORKS IN ACCORDANCE WITH AS 3798-2007. EXTERNAL WALL WRAP (SARKING) IN ACCORDANCE WITH NCC 2022 (IF APPLICABLE).
 EXHAUST FANS DUCTED TO OUTSIDE AIR (IF APPLICABLE).

SITE SPECIFIC CONTROLS			
CONTROL	DETAILS		
ACID SULPHATE SOIL	NO		
BIODIVERSITY	NO		
BUILDING ENVELOPE	NO		
BUSHFIRE	NO		
CLIMATE ZONE (NCC)	ZONE 7 - COOL TEMPERATE		
DESIGN WIND CLASSIFICATION	N2 (EXPOSED TBC)		
ESTATE/DEVELOPER GUIDELINES	NO		
FLOOD OVERLAY	NO		
HERITAGE	NO		
LANDSLIP HAZARD	NO		
MINIMUM FLOOR LEVEL	NO		
NATURAL ASSET CODE	NO		
NOISE ATTENUATION	NO		
SALINE SOIL	NO		
SHIELDING FACTOR	PS - PARTIAL SHIELDING		
SITE CLASSIFICATION	M		
SPECIFIC AREA PLAN OVERLAY	NO		
TERRAIN CATEGORY	TC2.5		
TOPOGRAPHIC CLASSIFICATION	T0		
WATERWAY & COASTAL OVERLAY	NO		
WIND REGION	A - NORMAL		
WITHIN 1km CALM SALT WATER	NO		
WITHIN 50km BREAKING SURF	37.00km		
ZONING	VILLAGE		


BUILDING CONTROLS & COMPLIANCE			
CONTROL	REQUIRED	PROPOSED	
SETBACKS			
FRONT	MIN. 4,500mm	5,749mm	
SIDE A	MIN. 3,000mm	6,000mm	
SIDE B	MIN. 3,000mm	3,625mm	
REAR	MIN. 3,000mm	7,915mm	
BULK & SCALE			
SITE AREA	602m²		
SITE COVERAGE	MAX. 50% 24.5%		
LANDSCAPE			
NO APPLICABLE CONTROLS			
EARTHWORKS			
CUT DEPTH	MAX. 2,000mm	389mm	
ACCESS & AMENITY			
PARKING SPACES	MIN. 2 SPACES	2 SPACES	
		•	

3D PERSPECTIVE

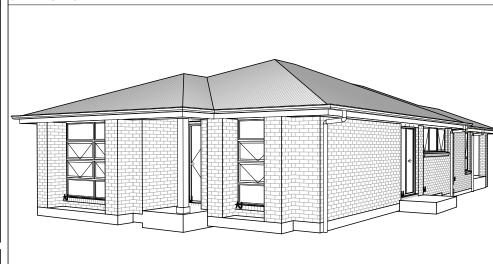

NOTE TO OWNER

THESE PLANS MAY FEATURE WORKS THAT ARE EXCLUDED FROM THE SCOPE OF WORKS WITH THE BUILDER, BUT THEY HAVE BEEN INCLUDED IN THESE DRAWINGS TO ASSIST IN THE OVERALL PLANNING AND ASSESSMENT OF THE BUILDING PROJECT. EXAMPLES OF SOME REGULARLY EXCLUDED WORKS INCLUDE DRIVEWAYS, RETAINING WALLS, SQUAR PANEL SPACING AND SITE DRAINAGE, PLEASE REFER TO YOUR SCOPE OF WORKS AND COLOUR SELECTIONS DOCUMENTATION FOR DETAILS OF INCLUDED WORKS. SOME DETAILS ARE INDICATIVE ONLY FOR EXAMPLE FLOORING, TILING, BRICKWORK AND CLADDING (EXPANSION JOINTS, ORIENTATION AND LAYOUT) AND ARE SUBJECT TO CHANGE.

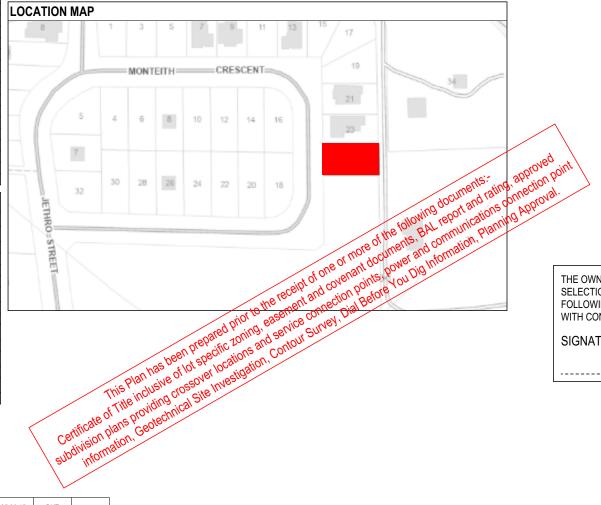

BUILDING INFORMATION

	GROUND FLOOR TOP OF WALL HEIGHT(S)	2445mm
NOTE: CEILING HEIGHT 45mm LOWER THAN TOP OF WALL		
	ROOF PITCH (U.N.O.)	23.0°
	ELECTRICITY SUPPLY	SINGLE PHASE
	GAS SUPPLY	NONE
	ROOF MATERIAL	SHEET METAL
	ROOF COLOUR	N/A
	WALL MATERIAL	BRICK VENEER
	SLAB CLASSIFICATION	TBC

INSULATION

	П	INCOLATION						
7		ROOF	SARKING UNDER ROOFING					
		CEILING	R4.1 BATTS (EXCL. GARAGE, ALFRESCO)					
		EXT. WALLS	R2.0 BATTS (EXCL. GARAGE) WALL WRAP TO ENTIRE HOUSE					
		INT. WALLS	R2.0 BATTS ADJACENT TO GARAGE AND AS PER PLA					
		FLOOR	BIAX SLAB R0.60					

NCC 2022 LIVABLE HOUSING COMPLIANCE

ACCESSIBLE SANITARY COMPARTMENT: ENS TOILET ACCESSIBLE SHOWER LOCATION: BATH

GENERAL NOTES:

- THRESHOLD OF ACCESSIBLE SHOWER ENTRY TO BE MAX. 5MM
- 1 EXTERIOR DOOR NOMINATED AS 870 OR GREATER TO ACHIEVE MIN 820MM CLEAR OPENING
- REFER TO APPLICABLE WET AREA PLANS AND INTERIOR **ELEVATIONS OR LOCATIONS OF REQUIRED WALL** REINFORCEMENT FOR FUTURE GRAB RAIL INSTALLATION.

THE OWNERS ACKNOWLEDGE THAT THESE CONTRACT PLANS MAY NOT REFLECT ALL THE

SELECTIONS THAT HAVE BEEN MADE OR CHANGES REQUESTED. THE OWNERS AGREE THAT FOLLOWING THE COLOUR SELECTIONS VARIATION OR UPDATING OF PLANS, THEY WILL BE PROVIDED WITH CONSTRUCTION PLANS FOR SIGNATURE PRIOR TO COMMENCEMENT OF CONSTRUCTION.

SIGNATURE: DATE:

SUBJECT TO NCC 2022

(1 MAY 2023) WATERPROOFING & PLUMBING

PLAN ACCEPTANCE BY OWNER SIGNATURE: DATE:

SIGNATURE: DATE:

PLEASE NOTE THAT VARIATIONS WILL NOT BE ACCEPTED AFTER THIS PLAN ACCEPTANCE HAS BEEN SIGNED

PRELIMINARY PLAN SET

PRELIMINARY PLAN SET - INITIAL ISSUE

AMENDMENT

No.

PRELIMINARY PLAN SET - EXTERNAL STAIR REMOVED

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FICATION: REVISION COVERY DRAFT SALE PLAN - CT1 'RIGHT: 2 DRAFT SALE PLAN - CT1 UPDATE 025 3 PRELIM PLANS - INITIAL ISSUE 4 PRELIM PLANS - UPDATE

DRAWN HMI 28/08/2025 WILSON COMPLETE HMI 29/08/2025 ADDRESS: DKZ 15/09/2025 LOT / SECTION / CT:

2025.09.15

2025.09.11

DATE

ALL

SHEET

DKZ

NVO

DRAWN CHECK

NVO 11/09/2025 25 MONTEITH CR, BAGDAD TAS 7030 13 / - / 185527 SOUTHERN MIDLANDS

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IN ANY WAY REPRODUCE, COPY, MODIFY, USE OR TAKE ADVANTAGE OF THE DRAWING TO BUILD A HOUSE BASED ON THIS PLAN (WHETHER IN WHOLE OR IN PART) WITHOUT THE PRIOR WRITTEN CONSENT OF WILSON HOMES PTY LTD.

YORK 14 FACADE DESIGN: EXECUTIVE SHEET TITLE:

COVER SHEET

HOUSE CODE H-WDCYOR10SA FACADE CODE: F-WDCYOR10EXECA SHEET No.: SCALES 1 / 14 1:100

DO NOT SCALE DRAWINGS, USE FIGURED DIMENSIONS ONLY, CHEC AND VERIFY DIMENSIONS AND I EVELS PRIOR TO THE TO THE DRAFTING OFFICE.

714428

(COVER SHEET) FOR ALREGEDING INFORMATION REGARDING SUSTAINABILITY REQUIREMENTS 19/12/2025 SIFICATION GENERAL BUILT ING INFORMATION


APPROX. CUT/FILL

AI I NOA. OO I/I ILL					
CUT	27.72m³	62.37t			
FILL	0.00m ³	0.00t			
DIFFERENCE	27.72m³	62.37t			
62 TONNES OF EXPORT FILL					

LOT SIZE: 602m² HOUSE (COVERED AREA): 147.51m² SITE COVERAGE: 24.5%

DEB AREA

DROPPED EDGE BEAMS					
HEIGHT (mm)	SURFACE AREA (m²)				
86	0.61				
172	1.69				
257	0.51				
343	3.10				
	5.90 m²				

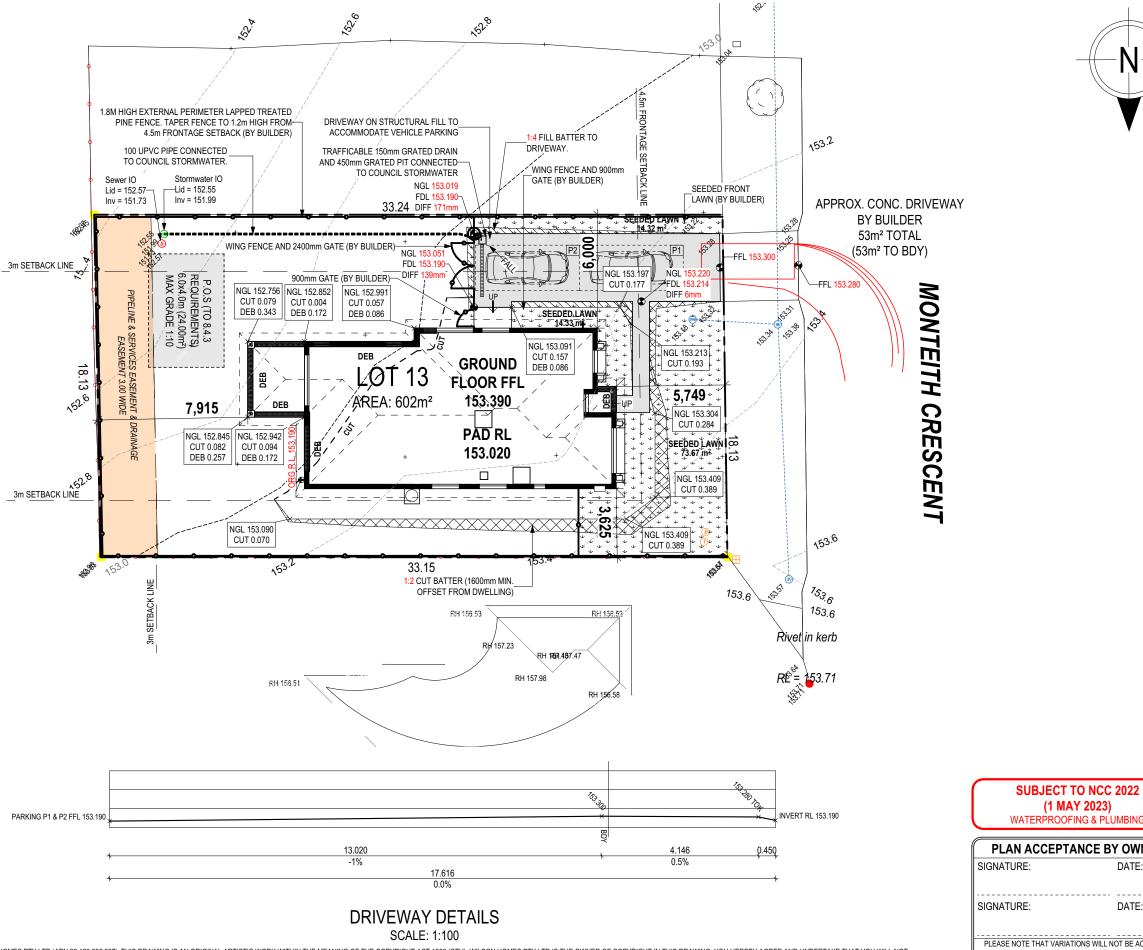

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PLAN ACCEPTANCE BY OWNER					
SIGNATURE:	DATE:				
SIGNATURE:	DATE:				

PLEASE NOTE THAT VARIATIONS WILL NOT BE ACCEPTED AFTER THIS PLAN ACCEPTANCE HAS BEEN SIGNED



SPECIFICATION:	$\overline{}$	REVISION	$\overline{}$	DRAWN	CLIENT:		HOUSE DESIGN:		HOUSE CODE:	DO NOT SCALE DRAWINGS, USE
DISCOVERY	1	DRAFT SALE PLAN - CT1	НМІ	28/08/2025	WILSON COMPLET	ΓE	YORK 14		H-WDCYOR10SA	FIGURED DIMENSIONS ONLY. CHECK AND VERIFY DIMENSIONS AND LEVELS PRIOR TO THE
COPYRIGHT:	2	DRAFT SALE PLAN - CT1 UPDATE		29/08/2025			FACADE DESIGN:		FACADE CODE:	COMMENCEMENT OF ANY WORK. ALL
© 2025	3	PRELIM PLANS - INITIAL ISSUE	NVO	11/09/2025	25 MONTEITH CR, E	3AGDAD TAS 7030	EXECUTIVE		F-WDCYOR10EXECA	DISCREPANCIES TO BE REPORTED TO THE DRAFTING OFFICE.
	4	PRELIM PLANS - UPDATE	DKZ	15/09/2025	LOT / SECTION / CT:	COUNCIL:	SHEET TITLE:	SHEET No.:		71///20
					13 / - / 185527	SOUTHERN MIDLANDS	SITE PLAN	2 / 14	1:200, 1:100	714428

ALL VEGETATION OUTSIDE THE BUILDING ZONE WILL BE MAINTAINED.

OWNER TO STABILISE THE SITE ON COMPLETION OF THE BUILD WITH TURF LAWNS, GRASS SEEDS, NATIVE GROUND COVERS AND/ OR MULCH SPREAD TO A DEPTH OF 75-100mm

THE FOLLOWING IS A STANDARD APPROACH. SEDIMENT AND EROSION CONTROL MEASURES WILL BE REVIEWED PRIOR TO COMMENCING WORK AND INSTALLED BASED ON THE OUTCOME OF THAT REVIEW.

1. ALL EROSION AND SEDIMENT CONTROL STRUCTURES TO BE INSPECTED EACH WORKING DAY AND MAINTAINED IN GOOD WORKING ORDER.

- 2. ALL GROUND COVER VEGETATION OUTSIDE THE IMMEDIATE BUILDING AREA TO BE PRESERVED DURING THE BUILDING
- 3. ALL EROSION AND SEDIMENT CONROL MEASURES TO BE INSTALLED PRIOR TO COMMENCEMENT OF MAJOR EARTHWORKS.
- 4. STOCKPILES OF CLAYEY MATERIAL TO BE COVERED WITH AN IMPERVIOUS SHEET.
- 5. ROOF WATER DOWNPIPES TO BE CONNECTED TO THE PERMAMENT UNDERGROUND STORMWATER DRAINAGE SYSTEM AS SOON AS PRACTICAL AFTER THE ROOF IS LAID.
- 6. DIVERSION DRAINS ARE TO BE CONNECTED TO A LEAGAL DISCHARGE POINT (COUNCIL STORMWATER SYSTEM, WATERCOURSE OR ROAD DRAIN). 7. SEDIMENT RETENTION TRAPS INSTALLED AROUND THE INLETS TO THE STORMWATER SYSTEM TO PREVENT SEDIMENT & OTHER DEBRIS BLOCKING THE DRAINS.

50 x 25 x 1000

STAR PICKET

NATURAL SURFACE

DOWNHILL OF MEMBRANE

NOT TO BE DISTURBED

STAKE OR

MEMBRANE TO BE BIDIM U24

OR APPROVED EQUIVALENT

NATURAL SURFACE LEVEL

SILT FENCING DETAIL


BURY APPROXIMATELY 150mm
OF MEMBRANE AND TEMPORARILY
BACKFILL TO RESTORE PRIOR

CONSTRUCTION SITE

GEOTEXTILE

FABRIC

RUNOFF FROM PAD

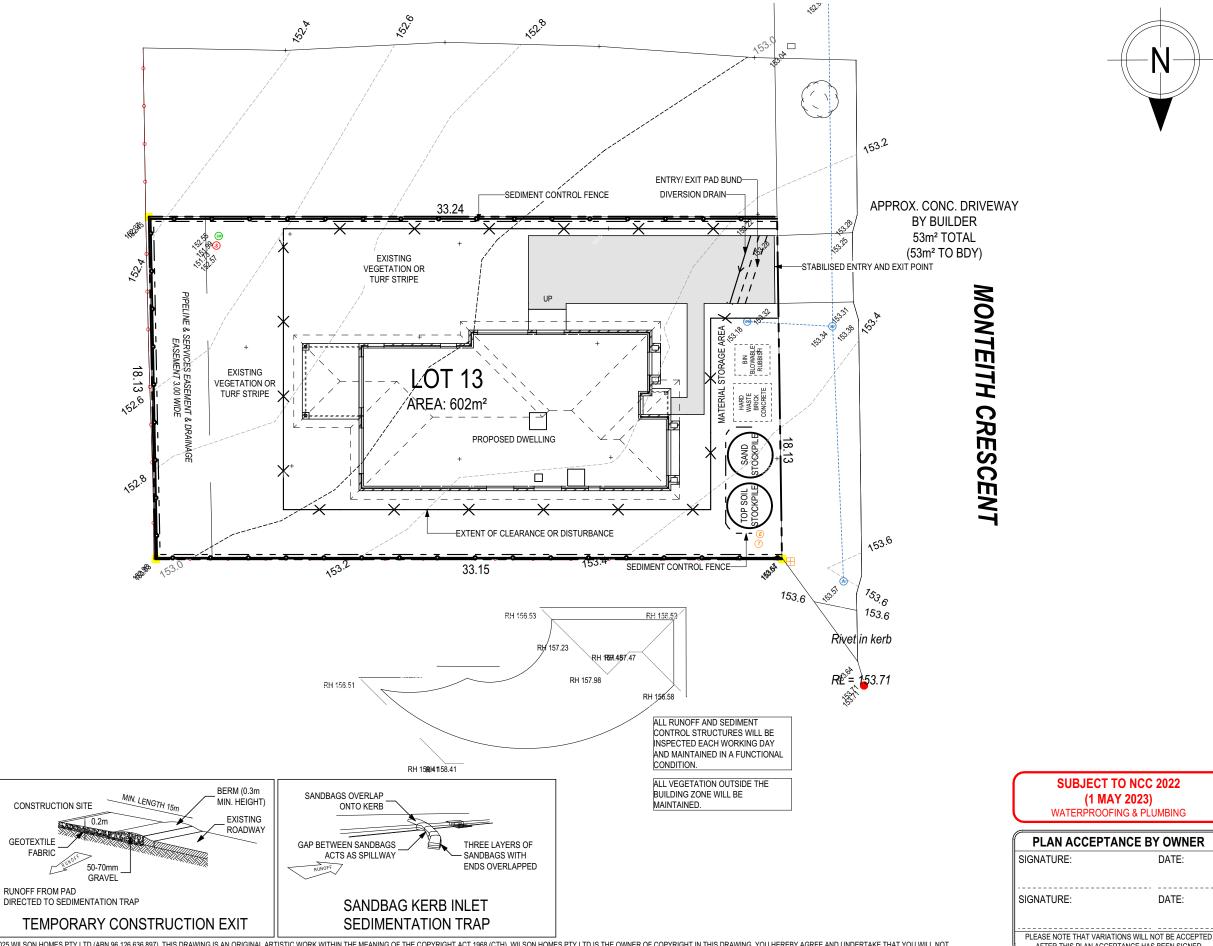

	© 2025 WILSON HOMES		RIGINAL ARTISTIC WORK WITHIN THE MEANING OF THE COPYRIGH E OR TAKE ADVANTAGE OF THE DRAWING TO BUILD A HOUSE BASI		OPYRIGHT IN THIS DRAWING. YOU HEREBY AGREE AND UNDERTAKE THAT YOU WILL NO HE PRIOR WRITTEN CONSENT OF WILSON HOMES PTY LTD.	T	AFTER THIS PLAN ACCEPT	TANCE HAS BEEN SIGNED	
Γ	SPECIFICATION:	REVISION	DRAWN CLIENT:		HOUSE DESIGN:		HOUSE CODE:	DO NOT SCALE DRAWINGS, USE	
	DISCOVERY	1 DRAFT SALE PLAN - CT1	HMI 28/08/2025 WILSON COMPLETE		YORK 14		H-WDCYOR10SA	FIGURED DIMENSIONS ONLY. CHEC AND VERIFY DIMENSIONS AND LEVELS PRIOR TO THE	
	COPYRIGHT:	2 DRAFT SALE PLAN - CT1 UPDATE	HMI 29/08/2025 ADDRESS:		FACADE DESIGN:			COMMENCEMENT OF ANY WORK. A	LL 3
	© 2025	3 PRELIM PLANS - INITIAL ISSUE	NVO 11/09/2025 25 MONTEITH CR, BA	GDAD TAS 7030	EXECUTIVE		F-WDCYOR10EXECA	DISCREPANCIES TO BE REPORTED TO THE DRAFTING OFFICE.	, .
	HUIIIE2	4 PRELIM PLANS - UPDATE	DKZ 15/09/2025 LOT / SECTION / CT:	COUNCIL:	SHEET TITLE:	SHEET No.:	SCALES:	71//10	7
			13 / - / 185527	SOUTHERN MIDLANDS	SOIL & WATER MANAGEMENT PLAN	3 / 14	1:200	714428	١.

SUBJECT TO NCC 2022

(1 MAY 2023)

WATERPROOFING & PLUMBING

DATE:

DATE:

ANY PART OF THE FASCIA, GUTTERING OR DOWNPIPE THAT IS WITHIN 450mm OF ANY BOUNDARY IS TO BE NON-COMBUSTIBLE IN ACCORDANCE WITH NCC 2022

ALL EXTERIOR SLABS TO BE GRADED BY CONCRETER TO ACHIEVE APPROX. 1:100 FALL TO OUTSIDE EDGE WITH MAXIMUM CROSSFALL OF 30mm OVER ENTIRE SLAB.

MAIN DWELLING, GROUND FLOOR ALFRESCO

SITE CLASSIFICATION GENERAL BUILDING INFORMATION PORCH ALL MECHANICAL VENTILATION TO BE DISCHARGED TO OUTDOOR AIR AS PER NCC 2022 REQUIREMENTS

FIRE RESISTANT PLASTERBOARD TO BE INSTALLED BEHIND COOKTOP

REFER TO SHEET (COVER SHEET) FOR ALL BUILDING INFORMATION REGARDING:

SUSTAINABILITY REQUIREMENTS

ALL GROUND FLOOR BULKHEAD AND SQUARE SET OPENING FRAMES TO BE 2155 ABOVE FFL UNLESS NOTED OTHERWISE

REFER TO WINDOW AND DOOR SCHEDULES FOR FULL DETAILS OF ALL WINDOWS AND DOORS. PLEASE NOTE WINDOW AND DOOR SIZES ARE BASED ON MANUFACTURERS SPECIFICATIONS AT DEPOSIT STAGE AND MAY DIFFER SLIGHTLY TO THE SIZES NOMINATED IN THE SCOPE OF WORKS DUE TO MANUFACTURING CHANGES AT THE TIME OF CONSTRUCTION.

FINAL WINDOW AND EXTERIOR DOOR LOCATIONS MAY BE ADJUSTED ON SITE TO SUIT BRICKWORK GAUGE

UNLESS NOTED OTHERWISE ALL ROOMS ARE REFERENCED AS FOLLOWS:




LEGEND HS / WS HOB SPOUT / WALL SPOUT FACE BRICK / COMMON BRICK SOUND INSULATION BRICK ARTICULATION JOINT SDP STANDARD DOWNPIPE CDP CHARGED DOWNPIPE DENOTES DRAWER SIDE 3D MECHANICAL VENTILATION L.B.W LOAD BEARING WALL PLASTERBOARD FC FIBRE CEMENT THIS DOOR OPENS FIRST IJ, SMOKE ALARM


LIFT OFF HINGE

WATER POINT

GAS BAYONET

+

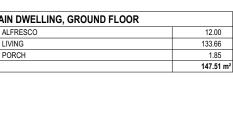

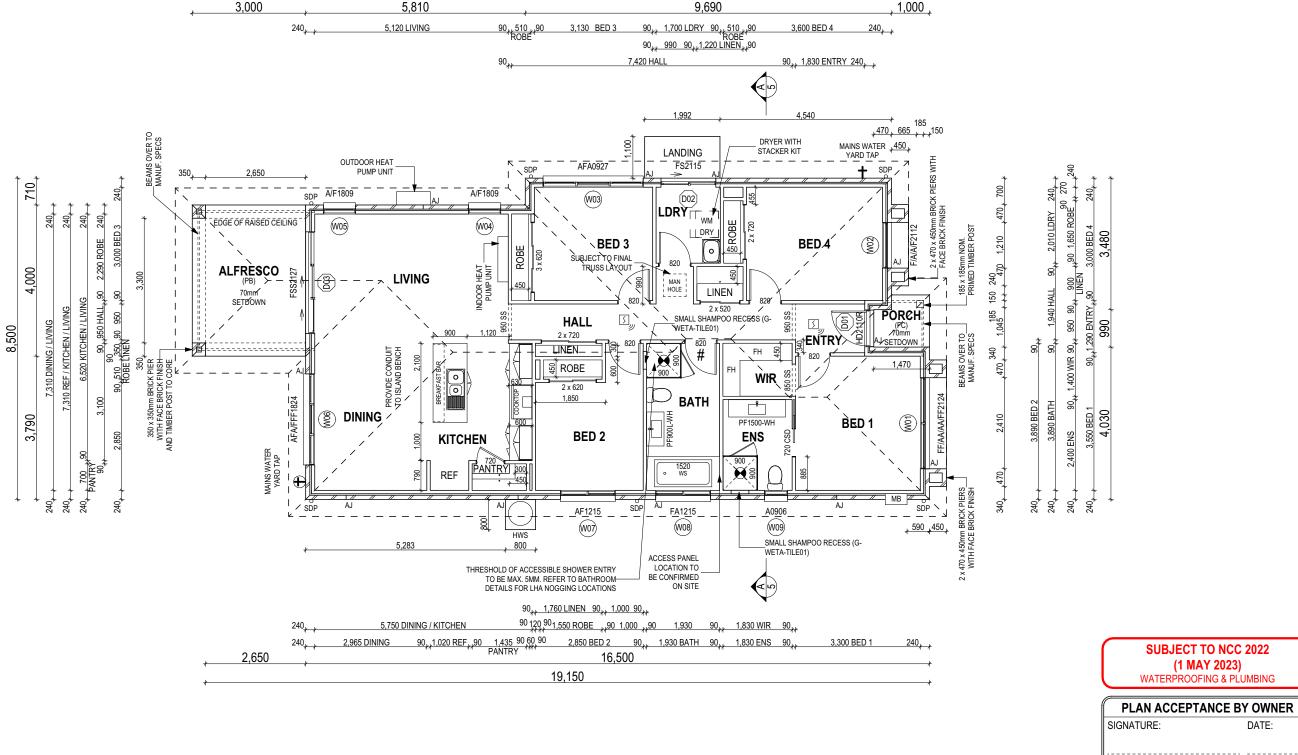

SIGNATURE:

SUBJECT TO NCC 2022

(1 MAY 2023)

PLEASE NOTE THAT VARIATIONS WILL NOT BE ACCEPTED AFTER THIS PLAN ACCEPTANCE HAS BEEN SIGNED

DATE:

DATE:

ALL DIMENSIONS ARE FRAME DIMENSIONS

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	IN ANY WAY REPRODUCE, COPY, MODIFY, USE OR TAKE	ADVANTAGE OF TH	E DRAWING TO BUILD A HOUSE BASED ON THIS PLAN (WHETHER IN WHOLE OR IN PART) WITHOUT THE PRIOR WRITTEN C	ONSENT OF WILSON HOMES PTY LTD.			Eie Eie
PECIFICATION:	REVISION	DRAWN	CLIENT:	HOUSE DESIGN:	HOUSE CODE:	DO NOT SCALE DRAWINGS, USE FIGURED DIMENSIONS ONLY. CHECK	_
DISCOVERY	1 DRAFT SALE PLAN - CT1		WILSON COMPLETE	YORK 14	H-WDCYOR10SA	AND VERIFY DIMENSIONS AND LEVELS PRIOR TO THE	4.04
OPYRIGHT:	2 DRAFT SALE PLAN - CT1 UPDATE		ADDRESS:	FACADE DESIGN:	1	COMMENCEMENT OF ANY WORK. ALL DISCREPANCIES TO BE REPORTED	on: 2
2025			25 MONTEITH CR, BAGDAD TAS 7030	EXECUTIVE	F-WDCYOR10EXECA	TO THE DRAFTING OFFICE.	Versi
	4 PRELIM PLANS - UPDATE	DKZ 15/09/2025	LOT / SECTION / CT: COUNCIL:		lo.: SCALES:	714428	olate
			13 / - / 185527 SOUTHERN MIDLANDS	GROUND FLOOR PLAN 4 / 14	1:100	/ 144ZO	emb


SOME DETAILS ON THIS SHEET ARE INDICATIVE ONLY FOR EXAMPLE BRICKWORK AND CLADDING (EXPANSION JOINTS, ORIENTATION AND LAYOUT) AND ARE SUBJECT TO CHANGE.

SH = SNAP HEADER SILL


BEDROOM WINDOW OPENINGS ABOVE 2m OFF THE SURFACE BENEATH TO BE RESTRICTED AS REQUIRED BY NCC 11.3.7 (VOLUME TWO)

ROOMS OTHER THAN BEDROOM WINDOW OPENINGS ABOVE 4m OFF THE SURFACE BENEATH TO BE RESTRICTED AS REQUIRED BY NCC 11.3.7 (VOLUME TWO)


REFER TO THE FOLLOWING DETAILS: BRICK COURSING W-BRIC-001

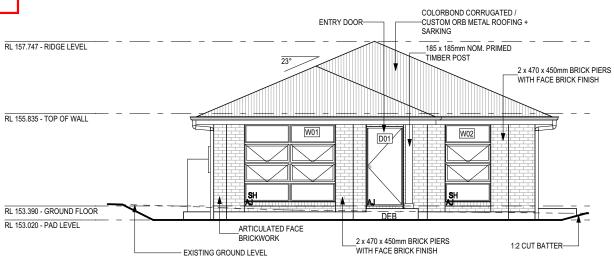

WEST ELEVATION SCALE: 1:100

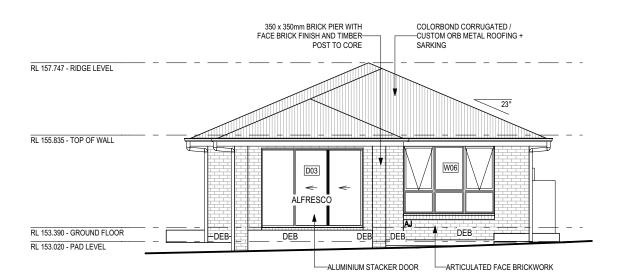


EAST ELEVATION SCALE: 1:100

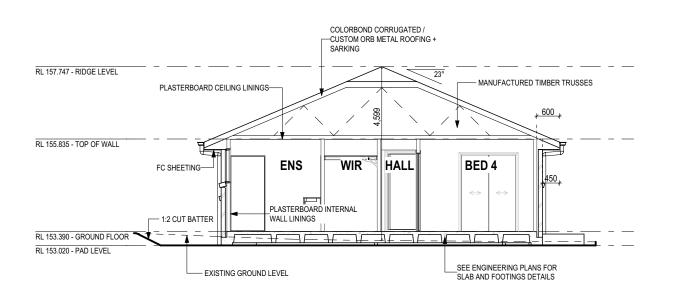

SECTION A-A SCALE: 1:100



WATERPROOFING & PLUMBING

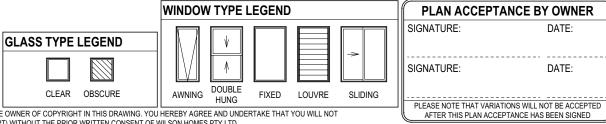

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SPECIFICATION:		REVISION	DRAWN CLIENT:	HOUSE DESIGN:	HOUSE CODE:	DO NOT SCALE DRAWINGS, USE
DISCOVERY		1 DRAFT SALE PLAN - CT1	HMI 28/08/2025 WILSON COMPLETE	YORK 14	H-WDCYOR10SA	FIGURED DIMENSIONS ONLY. CHECK AND VERIFY DIMENSIONS AND
COPYRIGHT:		2 DRAFT SALE PLAN - CT1 UPDATE	HMI 29/08/2025 ADDRESS:	FACADE DESIGN:	FACADE CODE:	LEVELS PRIOR TO THE COMMENCEMENT OF ANY WORK. ALL
© 2025		3 PRELIM PLANS - INITIAL ISSUE	NVO 11/09/2025 25 MONTEITH CR, BAGDAD TAS 7030	EXECUTIVE	F-WDCYOR10EXECA	DISCREPANCIES TO BE REPORTED TO THE DRAFTING OFFICE.
		4 PRELIM PLANS - UPDATE	DKZ 15/09/2025 LOT / SECTION / CT: COUNCIL:	SHEET TITLE: SHE	T No.: SCALES:	744400
			13 / - / 185527 SOUTHERN MIDLANDS	ELEVATIONS / SECTION 5 /	14 1:100	714428


SOME DETAILS ON THIS SHEET ARE
INDICATIVE ONLY FOR EXAMPLE
BRICKWORK AND CLADDING (EXPANSION
JOINTS, ORIENTATION AND LAYOUT) AND
ARE SUBJECT TO CHANGE.

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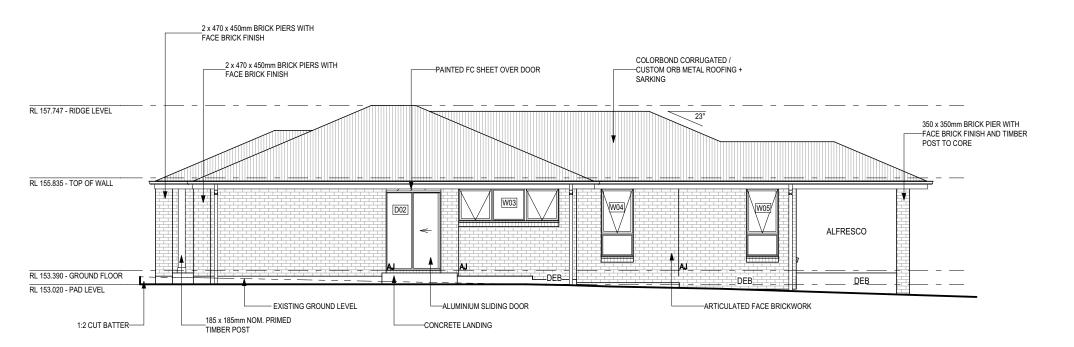
BEDROOM WINDOW OPENINGS ABOVE 2m OFF THE SURFACE BENEATH TO BE RESTRICTED AS REQUIRED BY NCC 11.3.7 (VOLUME TWO)

ROOMS OTHER THAN BEDROOM WINDOW OPENINGS ABOVE 4m OFF THE SURFACE BENEATH TO BE RESTRICTED AS REQUIRED BY NCC 11.3.7 (VOLUME TWO)

REFER TO THE FOLLOWING DETAILS: BRICK COURSING W-BRIC-001

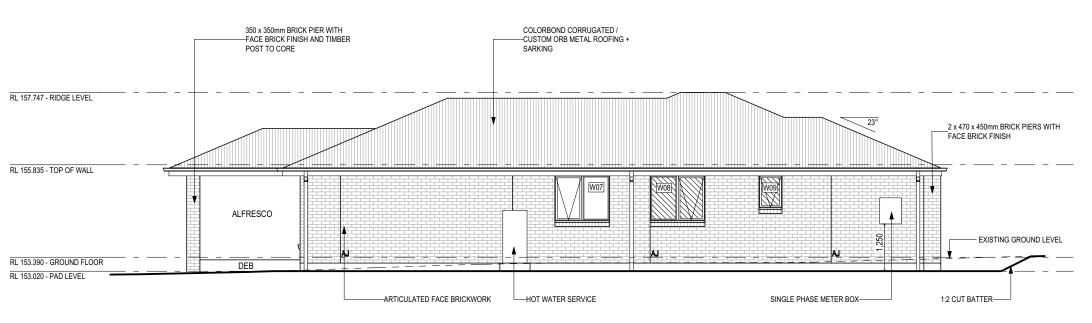

NORTH ELEVATION SCALE: 1:100




SOUTH ELEVATION SCALE: 1:100

V TYPE LEGEND

(1 MAY 2023)
WATERPROOFING & PLUMBING

PLAN ACCEPTANCE BY OWN

SUBJECT TO NCC 2022

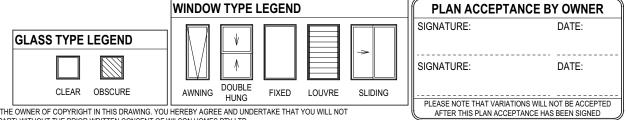

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	3 2020 WIEGON HOMEO					ON THIS PLAN (WHETHER IN WHOLE OR IN PART) WITHOUT THE PRIOR WRIT				AI TER THIS FEAR ACCEPT	AIN
SPECIFICATION:		REVISION		DRAWN	CLIENT:		НО	DUSE DESIGN:		HOUSE CODE:	Ē
DISCOVERY		1 DRAFT SALE PLAN - CT1	НМІ	28/08/2025	WILSON COMPLETE		Y	ORK 14		H-WDCYOR10SA	FIG
COPYRIGHT:		2 DRAFT SALE PLAN - CT1 UPDATE	1		ADDRESS:			CADE DESIGN:		FACADE CODE:	cc
© 2025		3 PRELIM PLANS - INITIAL ISSUE	NVO	11/09/2025	25 MONTEITH CR, BAGE	DAD TAS 7030	E)	XECUTIVE		F-WDCYOR10EXECA	
		4 PRELIM PLANS - UPDATE	DKZ	15/09/2025		COUNCIL:			SHEET No.:		
					13 / - / 185527	SOUTHERN MIDLANDS	EI	LEVATIONS	6 / 14	1:100	

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AND VERIFY DIMENSIONS AND LEVELS PRIOR TO THE COMMENCEMENT OF ANY WORK. AL DISCREPANCIES TO BE REPORTED TO THE DRAFTING OFFICE.

714428

No BAL / BAL 12.5			
Window Type	WERS Code	U Value	SHG
Sliding Window	DOW-022-003	2.9	0.64
Awning Window	DOW-005-001	3.9	0.58
Fixed External Window	DOW-038-001	3.03	0.71
Sliding Door	DAR-034-001	3.97	0.63
Stacking Door	DAR-034-001	3.97	0.63
Hinged Door	DOW-017-001	4.1	0.55
Bi-Fold Door	DOW-020-001	4.1	0.54
BAL 19			
Window Type	WERS Code	U Value	SHG
Sliding Window	TND-034-001	3.1	0.61
Awning Window	STG-001-066	3.91	0.54
Fixed External Window	DOW-038-005	3.02	0.66
Sliding Door	AUW-009-009	4.03	0.58
Stacking Door	AUW-009-009	4.03	0.58
Hinged Door	GRN-009-001	4.25	0.53
Bi-Fold Door	DOW-020-001	4.1	0.54
BAL 29			
Window Type	WERS Code	U Value	SHG
Sliding Window	TND-034-001	3.1	0.61
Awning Window	STG-001-066	3.91	0.54
Fixed External Window	DOW-038-005	3.02	0.66
Sliding Door	AMJ-007-005	4.03	0.59
Stacking Door	AMJ-007-005	4.03	0.59
Hinged Door	GRN-009-001	4.29	0.53

Windows supplied MUST HAVE Uw better and or equal to stated figures and SHGC within +/- 5% of stated figures. Restricted windows to have their openability restricted as per N.C.C 11.3.6.

WINDOW & DOOR SCHEDULES

7 / 14

NOTE: INTERNAL DOORS TO WET AREAS WITH MECHANICAL VENTILATION TO BE UNDERCUT 20mm

13 / - / 185527

HEIGHT WIDTH GLAZING TYPE ADDITIONAL INFORMATION

LIFT-OFF HINGES

REFER TO SHEET 1 (COVER SHEET) FOR ALL BUILDING INFORMATION REGARDING: - SUSTAINABILITY REQUIREMENTS - SITE CLASSIFICATION - GENERAL BUILDING INFORMATION

GROUND FLOOR 1

GROUND FLOOR 1

GROUND FLOOR 2

GROUND FLOOR 1

GROUND FLOOR 5

GROUND FLOOR 1

GROUND FLOOR 2

GROUND FLOOR

GROUND FLOOR

GROUND FLOOR

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PLAN ACCEPTANCE BY OWNER

SIGNATURE: DATE:

SIGNATURE: DATE:

SUBJECT TO NCC 2022

(1 MAY 2023)

WATERPROOFING & PLUMBING

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	SPECIFICATION
	DISCOV
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INTERIOR WINDOW & DOOR SCHEDULE
STOREY QTY CODE

2 x 520

2 x 620

2 x 720

3 x 620

720 CSD

720

820

820

850 SS

950 SS

TYPE

ROBEMAKER SLIDING

ROBEMAKER SLIDING

ROBEMAKER SLIDING

ROBEMAKER SLIDING

SQUARE SET OPENING

SQUARE SET OPENING

SWINGING

SWINGING

SWINGING

CAVITY SLIDING

2,040

2,040

2,040

2,040

2,040

2,040

2,040

2.040

2,155

2,155

1,060 N/A

1,260 N/A

1,460 N/A

1.860 N/A

720 N/A

720 N/A

820 N/A

820 N/A

850 N/A

950 N/A

	IN ANY IN ANY DEPONDENCE CORY MODIEV LICE OF TAKE	4 D. / 4 4 F	TAOE OF THE	DRAMMIC TO BUILD A LIQUIDE BACER O	NUTURO DU ANTARISETUED IN MUIOLE OD IN DADEN MITUOLIT THE DDIOD MIDITEN O	CONCENT OF WILLOWS DEVILED		
	IN ANY WAY REPRODUCE, COPY, MODIFY, USE OR TAKE	ADVAN	TAGE OF THE	DRAWING TO BUILD A HOUSE BASED O	ON THIS PLAN (WHETHER IN WHOLE OR IN PART) WITHOUT THE PRIOR WRITTEN C	CONSENT OF WILSON HOMES PTY LTD.		-
CATION:	REVISION		DRAWN	CLIENT:		HOUSE DESIGN:		HOUSE CODE:
OVERY	1 DRAFT SALE PLAN - CT1	HMI	28/08/2025	WILSON COMPLETE		YORK 14		H-WDCYOR10SA
SHT:	2 DRAFT SALE PLAN - CT1 UPDATE	НМІ	29/08/2025	ADDRESS:		FACADE DESIGN:		FACADE CODE:
5	3 PRELIM PLANS - INITIAL ISSUE	NVO	11/09/2025	25 MONTEITH CR, BAGD	OAD TAS 7030	EXECUTIVE	'	F-WDCYOR10EXECA
·	4 PRELIM PLANS - LIPDATE	DK7	15/09/2025	LOT / SECTION / CT:	COUNCIL:	SHEET TITLE:	SHEET No.:	SCALES:

SOUTHERN MIDLANDS

Template Version: 24.041 File Location: G:\Wilson\24.

8,810 10,590 1,000



CATCHMENT AREA 18.22 m² CATCHMENT AREA CATCHMENT AREA 33.70 m² 38.04 m² CATCHMENT ARÉA 31.64 m² CATCHMENT AREA CATCHMENT AREA 22.41 m² 37.63 m² FALL FALL

WHERE DOWNPIPES ARE FURTHER THAN 1.2m AWAY FROM VALLEY REFER TO N.C.C. 7.3.5(2)

POSITION AND QUALITY OF DOWNPIPES ARE NOT TO BE ALTERED WITHOUT CONSULTATION WITH DESIGNER.

AREA'S SHOWN ARE SURFACE AREAS/ CATCHMENT AREAS, NOT PLAN AREAS

Roofi	ng Data	
	171.04	Flat Roof Area (excluding gutter and slope factor) (m²)
	185.82	Roof Surface Area (includes slope factor, excludes gutter) (m²)
Dowr	pipe roof	calculations (as per AS/NZA3500.3:2021)
Ah	181.64	Area of roof catchment (including 115mm Slotted Quad Gutter) (m²)
Ac	219.78	Ah x Catchment Area Multiplier for slope (Table 3.4.3.2 from AS/NZS 3500.3:2021) (1.21 for 23° pitch) (m²)
Ae	6300	Cross sectional area of 57 x 115 Slotted Quad Gutter (mm²)
DRI	86	Design Rainfall Intensity (determined from Table E1 from AS/NZS 3500.3:2021)
Acdp	64	Catchment area per Downpipe (determined from Figure 3.5(A) from AS/NZS 3500.3:2021) (m²)
Required Downpipes	3.43	Ac / Acdp
Downpipes Provided	6	

17,400 3,000

SOFFIT EAVE VENT PROPOSED LOCATION TO BE MIN. 1M FROM CORNER JOINT

SUBJECT TO NCC 2022 (1 MAY 2023)
WATERPROOFING & PLUMBING

PLAN ACCEPTA	NCE BY OWNER
SIGNATURE:	DATE:
SIGNATURE:	DATE:
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		IN AIRT WAT RETRODUCE, OUT 1, MODIL 1, OUE OR TAKE AD	VAINTAGE OF T	IL DIAWING TO BOILD A HOUGE BAOLD	ON THIS TEAR (WHE THE KIN WHOLE OK INT AKT) WITHOUT THE TRIOK WITH TEN	ONOLIVI OF WILSON HOWLEST IT LIB.				证
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1	DISCOVERY 1	DRAFT SALE PLAN - CT1	HMI 28/08/202	WILSON COMPLETE		YORK 14	H	H-WDCYOR10SA	FIGURED DIMENSIONS ONLY. CHECK AND VERIFY DIMENSIONS AND	140
ı			HMI 29/08/202			FACADE DESIGN:	I .		LEVELS PRIOR TO THE COMMENCEMENT OF ANY WORK. ALL	
	© 2025	PRELIM PLANS - INITIAL ISSUE	NVO 11/09/202	25 MONTEITH CR, BAGI	DAD TAS 7030	EXECUTIVE	F	F-WDCYOR10EXECA	DISCREPANCIES TO BE REPORTED TO THE DRAFTING OFFICE.	/ersic
	4	PRELIM PLANS - UPDATE	DKZ 15/09/202	LOT / SECTION / CT:	COUNCIL:		HEET No.: S		714428	late \
				13 / - / 185527	SOUTHERN MIDLANDS	ROOF DRAINAGE PLAN 8	/ 14 1	1:100	, / 144ZO !	Lemb

NOT INDICATE THE BOARD SIZE OR DIRECTION OF THE ACTUAL FLOORING.


CARPET

LAMINATE

TILE (STANDARD WET AREAS)

TILE (UPGRADED AREAS)

DECKING

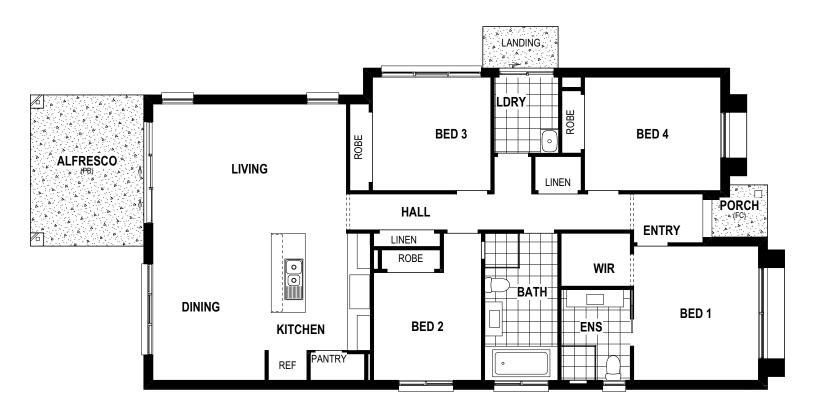

PLAN ACCEPT	ANCE BY OWNER
SIGNATURE:	DATE:
SIGNATURE:	DATE:
PLEASE NOTE THAT VARIA	TIONS WILL NOT BE ACCEPTED
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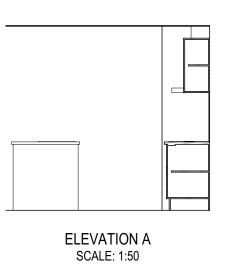
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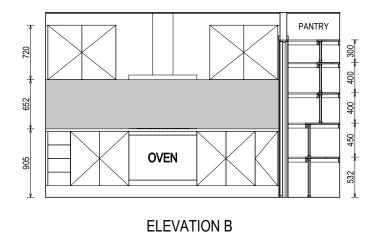
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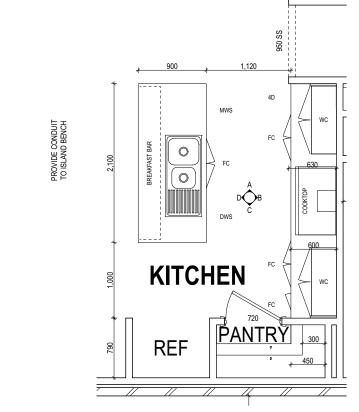
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PYRIGHT:	2 DRAFT SALE PLAN - CT1 UPDATE H	MI 29/08/2025	ADDRESS:		FACADE DESIGN:		FACADE CODE:	COM
2025	3 PRELIM PLANS - INITIAL ISSUE N	/O 11/09/2025	25 MONTEITH CR, BAG	DAD TAS 7030	EXECUTIVE		F-WDCYOR10EXECA	DISC
	4 PRELIM PLANS - UPDATE D	KZ 15/09/2025	LOT / SECTION / CT:	COUNCIL:		SHEET No.:	SCALES:	
			13 / - / 185527	SOUTHERN MIDLANDS	FLOOR COVERINGS	9 / 14	1:100	ı

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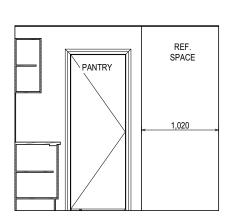


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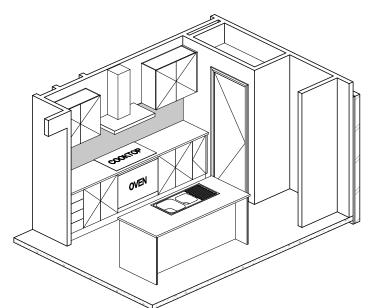



KITCHEN DETAILS

KITCHEN PLAN SCALE: 1:50




ELEVATION C SCALE: 1:50



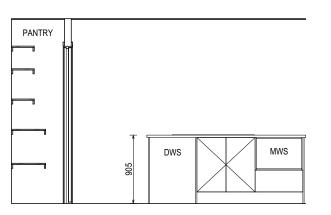

ELEVATION D SCALE: 1:50

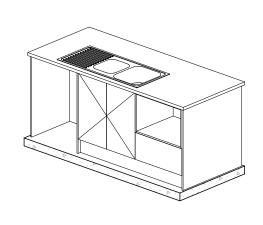

PLAN ACCEPTANCE BY OWNER						
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SIGNATURE:	DATE:					
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10 / 14 | 1:50

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COPYRIGHT:	2 DRAFT SALE PLAN - CT1 UPDATE	НМІ	29/08/2025	ADDRESS:		FACADE DESIGN:		FACADE CODE:
© 2025	3 PRELIM PLANS - INITIAL ISSUE	NVO	11/09/2025	25 MONTEITH CR, BAGE	DAD TAS 7030	EXECUTIVE		F-WDCYOR10EXECA
	4 PRELIM PLANS - UPDATE	DKZ	15/09/2025	LOT / SECTION / CT:	COUNCIL:	SHEET TITLE:	SHEET No.:	SCALES:

SOUTHERN MIDLANDS

13 / - / 185527

REFER TO SHEET 1 (COVER SHEET) FOR ALL BUILDING INFORMATION REGARDING: SUSTAINABILITY REQUIREMENTS SITE CLASSIFICATION

GENERAL BUILDING INFORMATION DETAILS DEPICTED ON THIS SHEET ARE A REPRESENTATION ONLY. JOINER MAY ADJUST CABINETRY AS REQUIRED.

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714428

VANITY DETAILS G-VANI-001
WINDOW OVER BATH HOB D-WIND-ALU001 STANDARD BATH HOB D-WETA-BATH003
WET AREA TILING LAYOUTS D-WETA-TILE002 SQUARE SET WINDOWS G-WIND-SSET02 FULL HEIGHT TILING D-LINI-WETA

REFER TO SHEET 1 (COVER SHEET) FOR ALL BUILDING INFORMATION REGARDING: SUSTAINABILITY REQUIREMENTS SITE CLASSIFICATION GENERAL BUILDING INFORMATION

DETAILS DEPICTED ON THIS SHEET ARE A REPRESENTATION ONLY

RSHR RAIL SHOWER

ROSE SHOWER ROSE SHOWER ELBOW

HOT TAP

COLD TAP

HOB SPOUT

WALL SPOUT

STOP COCK

TOILET ROLL HOLDER

TOWEL RAIL - SINGLE TR-D TOWEL RAIL - DOUBLE

TOWEL LADDER

TOWEL HOLDER TR TOWEL RACK TMB TUMBLER HOLDER RNG TOWEL RING

ROBE HOOK

SHAMPOO RECESS SOAP SOAP HOLDER

SHLF SHELF SR

CONNECTION MIX MIXER TAP

LEGEND

ELBW

HT

CT

HS

WS


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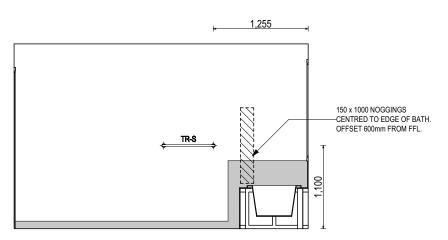
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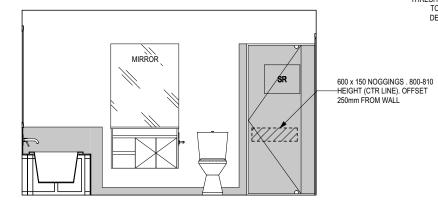
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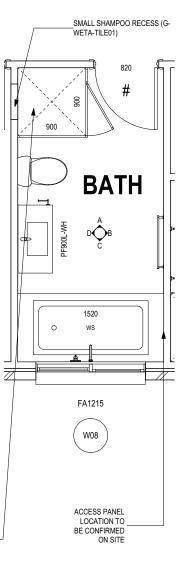
ELEVATION B SCALE: 1:50



ELEVATION C SCALE: 1:50



ELEVATION D SCALE: 1:50

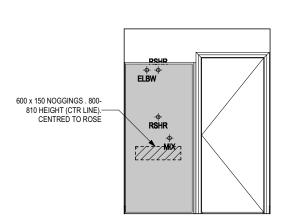

BATHROOM PLAN SCALE: 1:50

SHAMPOO	RECESS SIZE	STRUCTU	RAL DIMENSIONS
		WIDTH	HEIGHT
'SMALL"	470 x 380mm	548mm	446mm
'MEDIUM"	800 x 380mm	878mm	446mm
'LARGE"	1500 x 380mm	1578mm	446mm

SUBJECT TO NCC 2022

(1 MAY 2023) WATERPROOFING & PLUMBING

PLAN ACCEPTAI	NCE BY OWNER
SIGNATURE:	DATE:
SIGNATURE:	DATE:
PLEASE NOTE THAT VARIATIO	DNS WILL NOT BE ACCEPTED
AFTER THIS PLAN ACCEPT	TANCE HAS BEEN SIGNED

ALL DIMENSIONS ARE FRAME DIMENSIONS

600 x 150 NOGGINGS CENTRED TO BATH. OFFSET 175mm FROM TOP OF BATH

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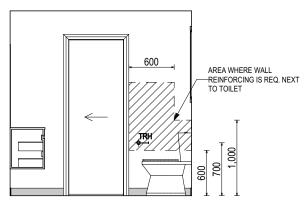


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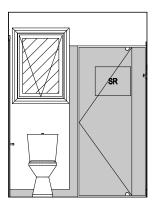
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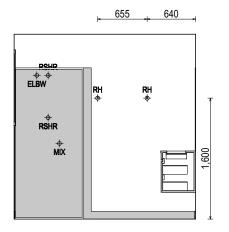
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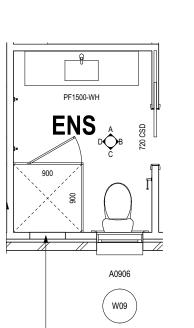
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ELEVATION C SCALE: 1:50



ELEVATION D SCALE: 1:50



REFER TO THE FOLLOWING DETAILS:

VANITY DETAILS G-VANI-001
WINDOW OVER BATH HOB D-WIND-ALU001

STANDARD BATH HOB D-WETA-BATH003
WET AREA TILING LAYOUTS D-WETA-TILE002

SQUARE SET WINDOWS G-WIND-SSET02 FULL HEIGHT TILING D-LINI-WETA

ENSUITE PLAN SCALE: 1:50

_SMALL SHAMPOO RECESS (G-WETA-TILE01)

SHAMPOO	RECESS SIZE	STRUCTURA	L DIMENSIONS			
		WIDTH	HEIGHT			
"SMALL"	470 x 380mm	548mm	446mm			
"MEDIUM"	800 x 380mm	878mm	446mm			
"LARGE"	1500 x 380mm	1578mm	446mm			
REFER WILSON HOMES' DETAIL G-WETA-TILE01 FOR FURTHER DETAIL PRIOR TO INSTALLATION.						

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		13 / - / 185527	SOUTHERN MIDLANDS	ENSUITE DETAILS	12 / 14	1:50	714428

REFER TO SHEET 1 (COVER SHEET) FOR ALL BUILDING INFORMATION REGARDING:

SUSTAINABILITY REQUIREMENTS

DETAILS DEPICTED ON THIS SHEET ARE A REPRESENTATION ONLY

RSHR RAIL SHOWER ROSE SHOWER ROSE SHOWER ELBOW ELBW CONNECTION MIX MIXER TAP HT HOT TAP

CT COLD TAP

HS HOB SPOUT

WALL SPOUT SC STOP COCK

ROBE HOOK

SR SHAMPOO RECESS SOAP SOAP HOLDER

TOILET ROLL HOLDER TR-S TOWEL RAIL - SINGLE TR-D TOWEL RAIL - DOUBLE TL TOWEL LADDER TH TOWEL HOLDER TR TOWEL RACK TMB TUMBLER HOLDER RNG TOWEL RING

WS

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RH

SHLF SHELF


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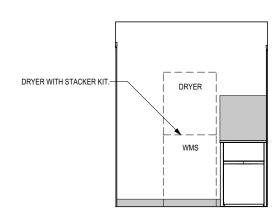
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- SUSTAINABILITY REQUIREMENTS

SITE CLASSIFICATIONGENERAL BUILDING INFORMATION


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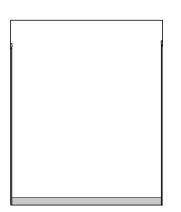
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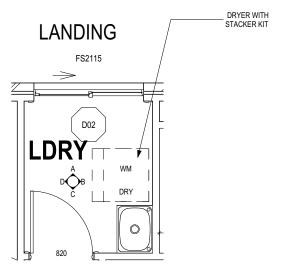
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SCALE: 1:50



LAUNDRY PLAN SCALE: 1:50

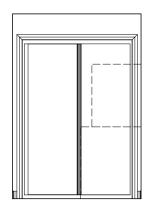SUBJECT TO NCC 2022 (1 MAY 2023)

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PLAN ACCEPTANCE BY OWNER SIGNATURE: DATE: SIGNATURE: DATE: PLEASE NOTE THAT VARIATIONS WILL NOT BE ACCEPTED AFTER THIS PLAN ACCEPTANCE HAS BEEN SIGNED
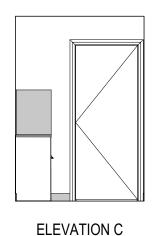
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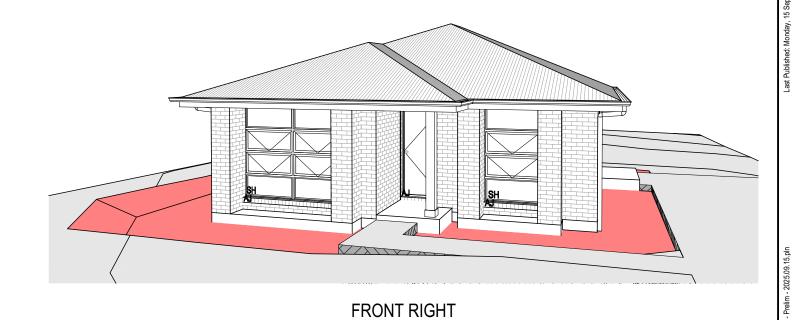
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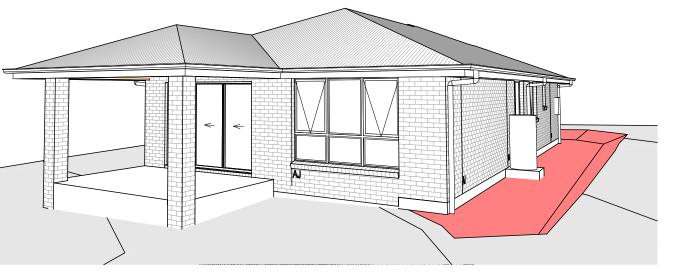
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FRONT LEFT



REAR LEFT



REAR RIGHT

SUBJECT TO NCC 2022 (1 MAY 2023) WATERPROOFING & PLUMBING

PLAN ACCEPTANCE BY OWNER

THIS PLAN HAS BEEN DRAWN TO REFLECT YOUR
CONSOLIDATED TENDER. PLEASE CHECK THAT EVERYTHING
IS CORRECT AND FINALISED. FURTHER STRUCTURAL
CHANGES ARE NOT POSSIBLE PAST THIS POINT.
PLEASE NOTE, SELECTIONS ITEMS WILL NOT APPEAR ON
YOUR PLANS UNTIL AFTER YOUR INTERNAL COLOUR
SELECTIONS APPOINTMENT IS COMPLETE.

SIGNATURE: DATE:

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		PRELIM PLANS - INITIAL ISSUE	NVO	11/09/2025		
	4	PRELIM PLANS - UPDATE	DKZ	15/09/2025		

2025 WILSON COMPLETE

2025 ADDRESS:
2025 25 MONTEITH CR, BAGDAD TAS 7030

2025 LOT/SECTION/CT: COUNCIL:

13 / - / 185527 SOUTHERN MIDLANDS

YORK 14

FACADE DESIGN:
EXECUTIVE
SHEET TITLE:
3D VIEWS

HOUSE CODE:

14 / 14

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714428



AS2870:2011 SITE ASSESSMENT

25 Monteith Crescent Bagdad July 2025

Wilson Homes Reference: 714428



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Investigation Details

Client: Wilson Homes- Multi Res Division

Site Address: 25 Monteith Crescent, Bagdad

Date of Inspection: 16/07/2025

Proposed Works: New house

Investigation Method: Geoprobe 540UD - Direct Push

Inspected by: C. Cooper

Site Details

Certificate of Title (CT): 185527/13

Title Area: Approx. 616.3 m²

Applicable Planning Overlays: No planning scheme overlays identified

Slope & Aspect: 1° S facing slope

Vegetation: Grass & Weeds

Background Information

Geology Map: MRT

Geological Unit: Quaternary Sediments

Climate: Annual rainfall 450mm

Water Connection: Mains

Sewer Connection: Serviced-Mains

Testing and Classification: AS2870:2011, AS1726:2017 & AS4055:2021



Investigation

A number of bore holes were completed to identify the distribution and variation of the soil materials at the site, bore hole locations are indicated on the site plan. See soil profile conditions presented below. Tests were conducted across the site to obtain bearing capacities of the material at the time of this investigation.

Soil Profile Summary

BH 1 Depth (m)	BH 2 Depth (m)	uscs	Description
0.00-0.30	0.00-0.40	SM Silty SAND: dark grey, brown, slightly moist, medium dense	
0.30-0.80		СН	Silty CLAY : high plasticity, grey, brown, slightly moist, stiff
0.80-1.60	0.40-1.10	CL	Sandy CLAY: medium plasticity, brown, slightly moist, stiff
1.60-1.70	1.10-1.20	SC	Clayey SAND: pale grey, slightly moist, very dense, refusal on cemented material

Site Notes

Soils on the site are developing from quaternary sediments, the clay fraction is likely to show moderate ground surface movement with moisture fluctuations.

Site Classification

The site has been assessed and classified in accordance with AS2870:2011 "Residential Slabs and Footings".

The site has been classified as:

Class M

y_s range: **20-40mm**

Notes: that is a moderately reactive clay.



Wind Loading Classification

According to "AS4055:2021 - Wind Loads for Housing" the house site is classified below:

Wind Classification:				
Region:	Α			
Terrain Category:	2.5			
Shielding Classification:	PS			
Topographic Classification:	T0			
Wind Classification:	N2			
Design Wind Gust Speed – m/s (V _{h,u}):	40			

Construction Notes & Recommendations

The site has been classified as **Class M** - Moderately reactive clay or silt site, which may experience moderate ground movement from moisture changes.

It is recommended that all footings be founded in the natural material with bearing capacities >100kPa.

All earthworks on site must comply with AS3798:2007, and I further recommend that consideration be given to drainage and sediment control on site during and after construction. Care should also be taken to ensure there is adequate drainage in the construction area to avoid the potential for weak bearing and foundation settlement associated with excessive soil moisture.

I also recommend that during construction that I and/or the design engineer be notified of any major variation to the foundation conditions as predicted in this report.

Dr John Paul Cumming B.Agr.Sc (hons) PhD CPSS GAICD

Director



Explanatory Notes

1 Scope of Works

The methods of description and classification of soils used in this report are based largely on Australian Standard 1726 – Geotechnical Site Investigations (AS1726:2017), with reference to Australian Standard 1289 – Methods for testing soils for engineering purposes (AS1289), for eventual Site Classification according to Australian Standard 2870 (AS2870:2011) – Residential Slabs and Footings and Australian Standard 1547 (AS1547:2012) On-site domestic wastewater management.

1.1 Site Classification AS2870:2011

Site classification with reference to the above Australian Standards are based on site reactivity.

Class	Foundation Conditions	Characteristic Surface Movement
Α	Most sand and rock sites with little or no ground movement from moisture changes.	0mm
S	Slightly reactive clay sites, which may experience only slight ground movement from moisture changes.	0 – 20mm
M	Moderately reactive clay or silt sites, which may experience moderate ground movement from moisture changes.	20 – 40mm
H-1	Highly reactive clay sites, which may experience high ground movement from moisture changes.	40 – 60mm
H-2	Highly reactive clay sites, which may experience very high ground movement from moisture changes.	60 – 75mm
E	Extremely reactive sites, which may experience extreme ground movement from moisture changes.	>75mm

Note: Soils where foundation performance may be significantly affected by factors other than reactive soil movement are classified as **Class P**.

A site is classified as Class P when:

- The bearing capacity of the soil profile in the foundation zone is generally less than 100kpa
- If excessive foundation settlement may occur due to loading on the foundation.
- The site contains uncontrolled fill greater than 0.8m in depth for sandy sites and 0.4m in depth for other soil materials.
- The site is subject to mine subsistence, landslip, collapse activity or coastal erosion.
- The site is underlain by highly dispersive soils with significant potential forerosion
- If the site is subject to abnormal moisture conditions which can affect foundation performance



1.2 Soil Characterisation

This information explains the terms of phrase used within the soil description area of the report.

It includes terminology for cohesive and non-cohesive soils and includes information on how the Unified Soil Classification Scheme (USCS) codes are determined.

NON COHSIVE - SAND & GRAVEL							
Consistency Description	Dynamic Cone Penetrometer blows/100 mm						
Very loose (VL)	loose (VL) Easily penetrated with 13 mm reinforcing rod pushed by hand. 0 - 1						
Loose (L)	Easily penetrated with 13 mm reinforcing rod pushed by hand. Can be excavated with a spade; 50 mm wooden peg can be easily driven.	1 - 3					
Medium dense (MD)	Penetrated 300 mm with 13 mm reinforcing rod driven with 2 kg hammer, - hard shovelling.	3 - 8					
Dense (D)	Penetrated 300 mm with 13 mm reinforcing rod driven with 2 kg hammer, requires pick for excavation: 50 mm wooden peg hard to drive.	8 - 15					
Very dense (VD)	Penetrated only 25 - 50 mm with 13 mm reinforcing rod driven with 2 kg hammer.	>15					

Consistency Description	Field Test	Indicative undrained shear strength kPa	
Very soft	Easily penetrated >40 mm by thumb. Exudes between thumb and fingers when squeezed in hand.	<12	
Soft	Easily penetrated 10 mm by thumb. Moulded by light finger pressure	>12 and <25	
Firm	Impression by thumb with moderate effort. Moulded by strong finger pressure	>25 and <50	
Stiff	Slight impression by thumb cannot be moulded with finger.	>50 and <100	
	Very tough. Readily indented by thumbnail.		
Very Stiff		>100 and <200	
	Brittle. Indented with difficulty by thumbnail.		
Hard		>200	



1.3 USCS Material Descriptions

Soils for engineering purposes are the unconsolidated materials above bedrock, they can be residual, alluvial, colluvial or aeolian in origin.

Major Divisions		Particle size mm	USCS Group Symbol	Typical Names			Labo	ratory Cla	essification	7.23
128	BOULDERS	200			%<	0.075 mm (2)	Plasticity of fine fraction	$C_{ii} = \frac{D_{e0}}{D_{ii}}$	$C_i = \frac{(D_{sc})^i}{(D_{sc})(D_{sc}}$	NOTES
E C	COBBLES	200								
S larger than 0.075 mm)		63	GW	Well graded gravels and gravel-sand mixtures, little or no fines		0-5	-	>4	Between 1 and 3	(1) Identify fines by the method given
R larger t	GRAVELS (more than	coarse	GP	Poorly graded gravels and gravel-sand mixtures, little or no fines, uniform gravels	'Wajor Divisions'	0-5	=		comply with	for fine-grained soils.
NED SO	half of coarse	medium	GM	Silty gravels, gravel-sand-silt mixtures (1)	Wajor [12-50	Below 'A' line or PI<4	1	-	
COARSE GRAINED SOILS derial less than 63 mm is la	fraction is larger than 2.36 mm)	6 fine 2.36	GC	Clayey gravels, gravel-sand- clay mixtures (1)	i gven in	12-50	Above 'A' line and Pt>7	-	-	(2) Borderline
COARS (more than half of material to	SANDS (more than		SW	Well graded sands and gravelly sands, little or no fines	he citteda	0-5	-	>6	Between 1 and 3	classifications occur when the percentage of fines (fraction
		0.6	SP	Poorly graded sands and gravelly sands, little or no fines	according to the	0-5	-		comply with	smaller than 0.075 mm size) is greater than
	fraction is smaller than 2.36 mm)	medium 0.2	SM	Silty sands, sand silt mixtures (1)	ons acc	12-50	Below 'A' line or PI<4	-	=	5% and less than 12%. Borderline
	*100 == 00 :	fine 0.075	SC	Clayey sands, sand-clay mixtures (1)	of fractions	12-50	Above 'A' line and PI>7		-	classifications require the use of SP-SM, GW- GC.
man 0.075 mm	0.075 mm		ML	Inorganic silts, very fine sands, rock flour, silty or clayey fine sands or clayey silts with slight plasticity	Plasticity Chart For classification of fine grained soils					ined soils
smaller	SILTS & CLA (Liquid Limit	3550	CL CI	Inorganic clays of low to medium plasticity, gravelly clays, sandy clays, silty clays, lean clays	3 63 mm for	80			n of coarse gr	rained soils.
SOILS			OL	Organic silts and clays of low plasticity	passin	10			/	100
FINE GRANED SOILS etal less than 63 mm is	MH or diato-maceous fine sands or silts, elastic silts SILTS & CLAYS (Liquid Limit >50%) CH Inorganic silts, mic-aceous fine sands or silts, elastic silts Inorganic silts, mic-aceous fine sands or diato-maceous fine sands or silts, elastic silts CH Inorganic silts, mic-aceous fine sands or diato-maceous fine sands or silts, elastic silts	8850	МН	or diato-maceous fine sands	of material	Plastic Index (%)				This the things
		Plastic	500	Sept.	MILE	DE:				
forma		Organic silts and clays of			adation	0	Zen	"	401	
(more than half of ma	HIGHLY OR	GANIC	PT	Peat and other highly organic soils	Use the gradation		10 20	se 40 Liqu	se eo aid Limit (%)	70 M2 96 100



Grain size analysis is performed by two processes depending on particle size. Sand silt and clay particles are assessed using a standardised hydrometer test, and coarse sand and larger is assessed through sieving by USCS certified sieves. For more detail see the following section.

Soil Classification	Particle Size			
Clay	Less than 0.002mm			
Silt	0.002 – 0.06mm			
Fine/Medium Sand	0.06 – 2.0mm			
Coarse Sand	2.0mm – 4.75mm			
Gravel	4.75mm – 60.00mm			

1.4 Bearing Capacities and DCP testing.


DCP and PSP weighted penetrometer tests – Dynamic Cone Penetrometer (DCP) and Perth Sand Penetrometer (PSP) tests are carried out by driving a rod into the ground with a falling weight hammer and measuring the blows for successive 100mm increments of penetration. Normally, there is a depth limitation of 1.2m but this may be extended in certain conditions by the use of extension rods. The methods for the two tests are quite similar.

- Dynamic Cone Penetrometer a 16mm rod with a 20mm diameter cone end is driven with a 9kg hammer dropping 510mm (AS 1289, Test 6.3.2).
- Perth Sand Penetrometer a 16mm diameter flat-ended rod is driven with a 9kg hammer, dropping 600mm (AS 1289 Test 6.3.3). This test was developed for testing the density of sands and is mainly used in granular soils and filling.

Site Anomalies – During construction GES will need to be notified of any major variation to the foundation conditions as predicted in this report.



1.5 Batter Angles for Embankments (Guide Only)

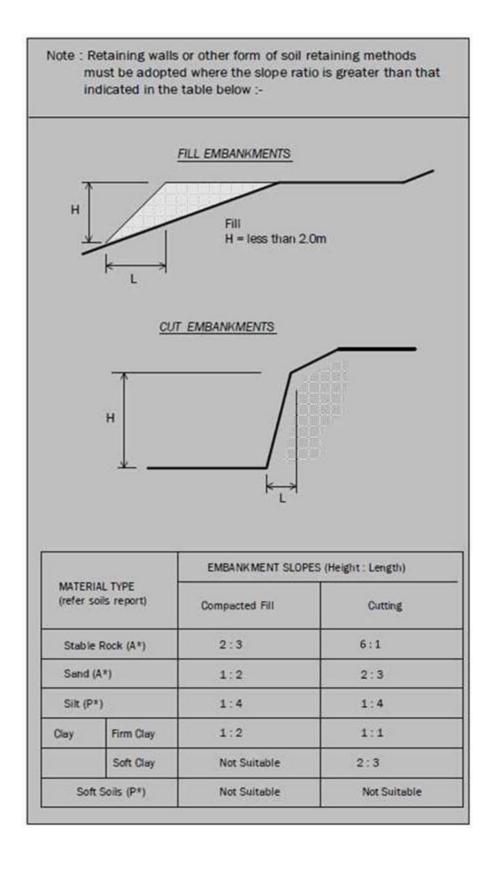



Glossary of Terms

Bearing Capacity – Maximum bearing pressure that can be sustained by the foundation from the proposed footing system under service loads which should avoid failure or excessive settlement.

Clay – (Mineral particles less than 0.002mm in diameter). Fine grained cohesive soil with plastic properties when wet. Also includes sandy clays, silty clays, and gravelly clays.

Dynamic Cone Penetrometer (DCP) – Field equipment used to determine underlying soil strength and therefore bearing capacity (kPa) by measuring the penetration of the device into the soil after each hammer blow.

Dispersive soil – A soil that has the ability to pass rapidly into suspension in water.

Footing – Construction which transfers the load from the building to the foundation.

Foundation – Ground which supports the building

Landslip – Foundation condition on a sloping site where downhill foundation movement or failure is a design consideration.

Qualified Engineer – A professional engineer with academic qualifications in geotechnical or structural engineering who also has extensive experience in the design of the footing systems for houses or similar structures.

Reactive Site – Site consisting of clay soil which swells on wetting and shrinks on drying by an amount that can damage buildings on light strip footings or unstiffened slabs. Includes sites classified as S, M, H-1, H-2 & E in accordance with AS2870-2011.

Sand – (Mineral particles greater than 0.02mm in diameter). Granular non-cohesive, non-plastic soil that may contain fines including silt or clay up to 15%.

Services – Means all underground services to the site including but not limited to power, telephone, sewerage, water & storm water.

Silt – (Mineral particles 0.002 - 0.02mm in diameter). Fine grained non-cohesive soil, non-plastic when wet. Often confers a silky smoothness of field texture, regularly includes clay and sand to form clayey silts, sandy silts and gravelly silts.

Site – The site title, as denoted by address, lot number, or Certificate of Title (CT) number, or Property Identification Number (PID).

Surface Movement (Ys) – Design movement (mm) at the surface of a reactive site caused by moisture changes.









Disclaimer

This Report has been prepared in accordance with the scope of services between Geo-Environmental Solutions Pty. Ltd. (GES) and the Client. To the best of GES's knowledge, the information presented herein represents the client's requirements at the time of printing of the Report. However, the passage of time, manifestation of latent conditions or impacts of future events may result in findings differing from that discussed in this Report. In preparing this Report, GES has relied upon data, surveys, analyses, designs, plans and other information provided by the Client and other individuals and organisations referenced herein. Except as otherwise stated in this Report, GES has not verified the accuracy or completeness of such data, surveys, analyses, designs, plans and other information.

The scope of this study does not allow for the review of every possible geotechnical parameter or the soil conditions over the whole area of the site. Soil and rock samples collected from the investigation area are assumed to be representative of the areas from where they were collected and not indicative of the entire site. The conclusions discussed within this report are based on observations and/or testing at these investigation points.

This report does not purport to provide legal advice. Readers of the report should engage professional legal practitioners for this purpose as required.

No responsibility is accepted for use of any part of this report in any other context or for any other purpose by a third party.























APPENDIX 1 - DCP Results Table

Dynamic Cone Penetration (DCP) Conversion to Californian Bearing Ratio (ref: Australian Standard AS 1289.6.3.2 - 1997)

DCP Location BH1


Depth (mm)	DCP	DCP	DCP Resistance	Allowable Bearing Capacity	CBR (Rounded Up)
	(Blows/100mm)	(mm/Blow)	(mPa)	(kPa)	
0-100 100-200	4 6	25.0 16.7	1.3 1.9	139 208	8 13
200-300	8	12.5	2.5	278	17
300-400 400-500	11 8	9.1 12.5	3.4 2.5	382 278	25 17
500-600	9	11.1	2.8	313	20
600-700 700-800	9 10	11.1 10.0	2.8 3.1	313 347	20 22
800-900	11	9.1	3.4	382	25
900-1000 1000-1100	12 12	8.3 8.3	3.8 3.8	417 417	27 27
1100-1200	15	6.7	4.7	521	35
1200-1300 1300-1400	15 20	6.7 5.0	4.7 6.3	521 694	35 48









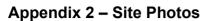







CERTIFICATE OF QUALIFIED PERSON – ASSESSABLE ITEM

Section 321

To:	Wilson Homes- Multi Res Divis	sion		Owner /Agent			
	250 Murray Street		Address	Form	, 5	5	
	Hobart	70	00	Suburb/postcode			
Qualified perso	on details:						
Qualified person:	John-Paul Cumming]			
Address:	29 Kirksway Place			Phone No:	03	6223	1839
	Battery Point	70	04	Fax No:			
Licence No:	AO999 Email address:	jcun	nming	j@geosolutio	ns.net	au	
Qualifications and Insurance details:	Certified Professional Soil Scientist (CPSS stage 2)	Certified Professional Soil (description from Column 3 of the Director's Determination - Certificates					
Speciality area of expertise:	AS2870-2011 Foundation Classification (description from Column 4 of the Director's Determination - Certificates by Qualified Persons for Assessable Items)						
Details of work	κ:						
Address:	25 Monteith Crescent				Lot No:		
	Bagdad	70	30	Certificate of	title No:	1855 3	527/1
The assessable item related to this certificate:	tem related to according to AS2870-2011 certified)						
Certificate deta	ails:						
Certificate type:	Certificate type: Foundation Classification (description from Column 1 of Schedule 1 of the Director's Determination - Certificates by Qualified Persons for Assessable Items n)						
This certificate is i	n relation to the above assessable item building work, plumbing work or or	r pluml	bing in	stallation or der	nolition		
	a building, ten	nporar	y struc	ture or plumbin	g install	ation: l	



In issuing this certificate the following matters are relevant -

Documents: The attached soil report for the address detailed above in 'details of

work'

Relevant

calculations:

Reference the above report.

References: AS2870:2011 residential slabs and footings

AS1726:2017 Geotechnical site investigations

CSIRO Building technology file – 18.

Substance of Certificate: (what it is that is being certified)

Site Classification consistent with AS2870-2011.

Scope and/or Limitations

The classification applies to the site as inspected and does not account for future alteration to foundation conditions as a result of earth works, drainage condition changes or variations in site maintenance.

I, John-Paul Cumming certify the matters described in this certificate.

Qualified person:


Signed:

Certificate No:

J11946

Date: 22/07/2025

PROFEO PROFEO DO PSS John Paul Cumming

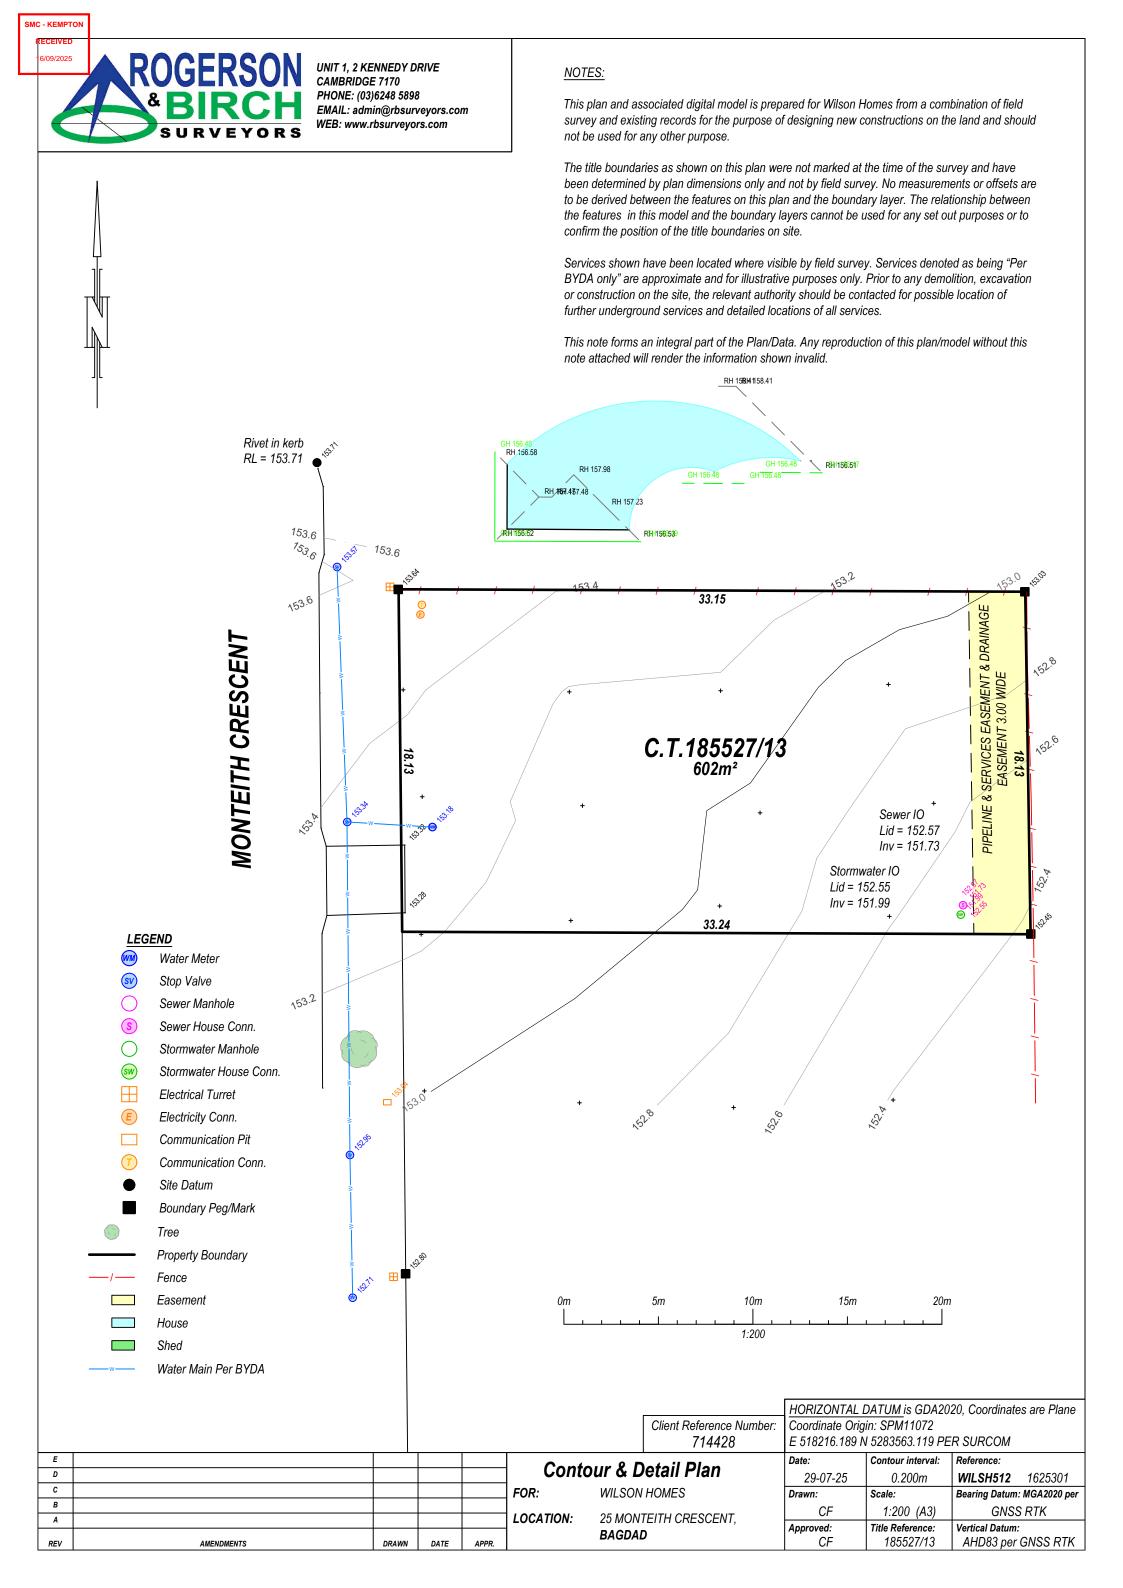



RESULT OF SEARCH

RECORDER OF TITLES

Issued Pursuant to the Land Titles Act 1980



SEARCH OF TORRENS TITLE

VOLUME	FOLIO
185527	13
EDITION 2	DATE OF ISSUE 15-Feb-2025

SEARCH DATE : 04-Jul-2025 SEARCH TIME : 11.31 AM

DESCRIPTION OF LAND

Parish of STRANGFORD Land District of MONMOUTH Lot 13 on Sealed Plan 185527 Derivation: Part of 60A-1R-34P Gtd. to C.A. Galletly and Anor.

Prior CT 36069/1

SCHEDULE 1

N160282 TRANSFER to WILSON HOMES TASMANIA PTY LTD Registered 15-Feb-2025 at 12.01 PM

SCHEDULE 2

Reservations and conditions in the Crown Grant if any SP185527 EASEMENTS in Schedule of Easements SP185527 COVENANTS in Schedule of Easements SP185527 FENCING COVENANT in Schedule of Easements

UNREGISTERED DEALINGS AND NOTATIONS

No unregistered dealings or other notations




FOLIO PLAN

RECORDER OF TITLES



Issued Pursuant to the Land Titles Act 1980

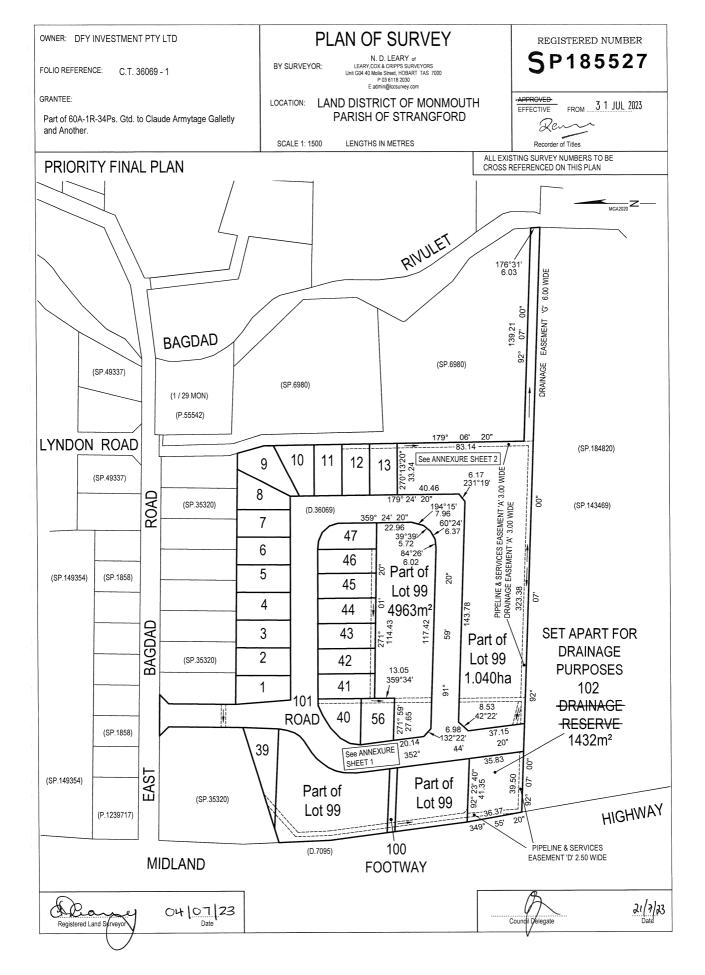




FOLIO PLAN

RECORDER OF TITLES



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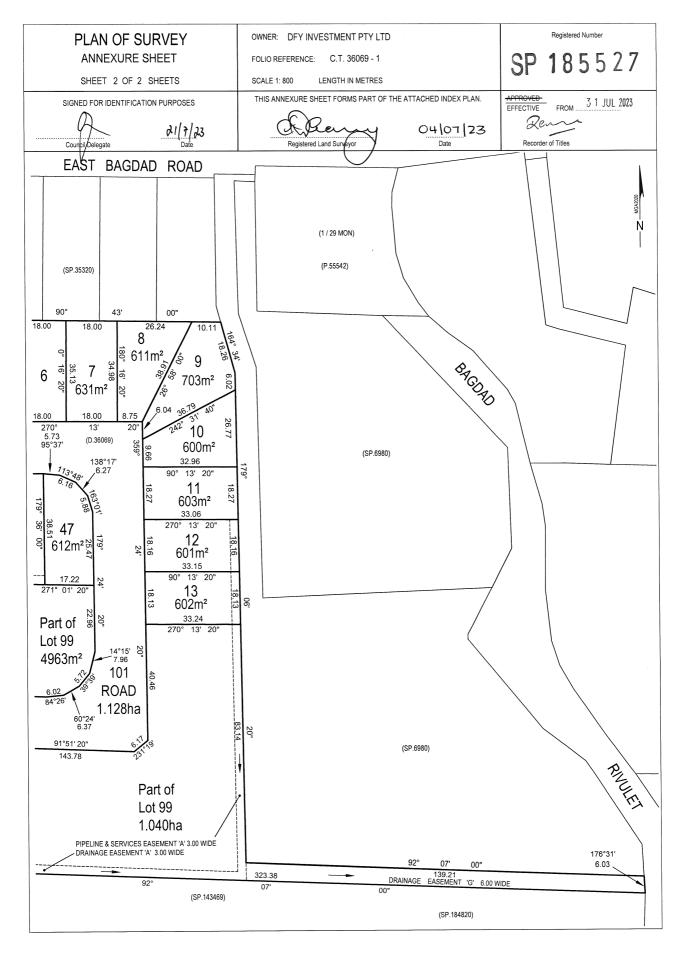


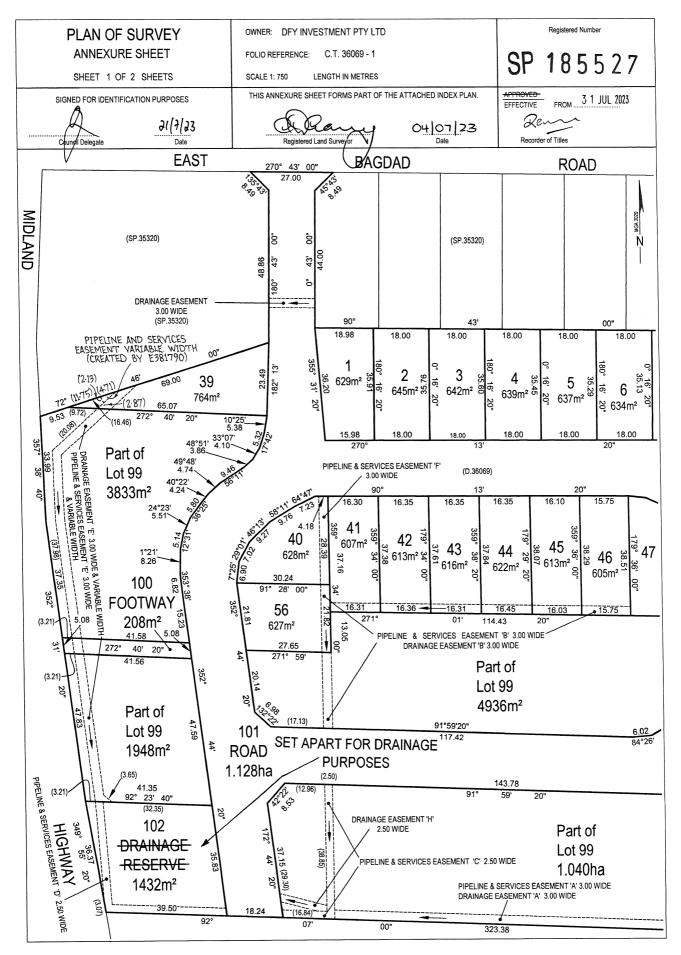FOLIO PLAN

RECORDER OF TITLES



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RECORDER OF TITLES

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SCHEDULE OF EASEMENTS

NOTE: THE SCHEDULE MUST BE SIGNED BY THE OWNERS & MORTGAGEES OF THE LAND AFFECTED. SIGNATURES MUST BE ATTESTED.

Registered Number

SP 185527

PAGE 1 OF 6 PAGES

EASEMENTS AND PROFITS

Each lot on the plan is together with:-

- (1) such rights of drainage over the drainage easements shown on the plan (if any) as may be necessary to drain the stormwater and other surplus water from such lot; and
- (2) any easements or profits a prendre described hereunder.

Each lot on the plan is subject to:-

- (1) such rights of drainage over the drainage easements shown on the plan (if any) as passing through such lot as may be necessary to drain the stormwater and other surplus water from any other lot on the plan; and
- (2) any easements or profits a prendre described hereunder.

The direction of the flow of water through the drainage easements shown on the plan is indicated by arrows.

Easements

Lots 12 & 13 on the Plan are subject to a Pipeline and Service Easement in gross in favour of TasWater over the area marked "PIPELINE & SERVICES EASEMENT 'A' 3.00 WIDE" shown on the Plan.

Lots 12 & 13 on the Plan are subject to a right of drainage in gross in favour of the Southern Midlands Council over the area marked "DRAINAGE EASEMENT 'A' 3.00 WIDE" shown on the Plan.

Pipeline and Service Easement in gross in favour of TasWater

Lot 39 on the Plan is subject to a right of drainage in gross in favour of the Southern Midlands Council

Lot 39 on the Plan is subject to a right of drainage in gross in layour of the Southern Midlands Council over the area marked "DRAINAGE EASEMENT," E' 3.00 WIDE & VARIABLE WIDTH" shown on the Plan.

4 "PIPELINE & SERVICES EASEMENT

Lot 39 on the Plan is subject to a right of drainage in gross in favour of the Southern Midlands Council over the area marked "DRAINAGE EASEMENT 'E' 3.00 WIDE," shown on the Plan.

& VARIABLE WIDTH"

Lot 40 on the Plan is subject to a Pipeline and Services Easement in gross in favour of TasWater over the area marked "PIPELINE & SERVICES EASEMENT 'F' 3.00 WIDE" shown on the Plan.

Lots 41-46 on the Plan are subject to a Pipeline and Services Easement in gross in favour of TasWater over the area marked "PIPELINE & SERVICES EASEMENT 'B' 3.00 WIDE" shown on the Plan.

Lots 41-46 on the Plan are subject to a right of drainage in gross in favour of the Southern Midlands Council over the area marked "DRAINAGE EASEMENT 'B' 3.00 WIDE" shown on the Plan.

M APPLACE MANY SIMLES 28/1/23

SUBDIVIDER: DFY INVESTMENT PTY LTD

FOLIO REF: CTs 36069/1

SOLICITOR

& REFERENCE: Abetz Curtis - 220233

PLAN SEALED BY:

DATE:

6A 2021/K

REF NO. Council Pelegate

NOTE: The Council Delegate must sign the Certificate for the purposes of identification.

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ANNEXURE TO SCHEDULE OF EASEMENTS

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FOLIO REFERENCE: C/T 36069/1

Lot 56 on the Plan is subject to a Pipeline and Services Easement in gross in favour of TasWater over the area marked "PIPELINE & SERVICES EASEMENT 'B' 3.00 WIDE" shown on the Plan.

Lot 56 on the Plan is subject to a right of drainage in gross in favour of the Southern Midlands Council over the area marked "DRAINAGE EASEMENT 'B' 3.00 WIDE" shown on the Plan.

Lot 99 on the Plan is subject to a Pipeline and Services Easement in gross in favour of TasWater over the area marked "PIPELINE & SERVICES EASEMENT 'B' 3.00 WIDE" shown on the Plan.

Lot 99 on the Plan is subject to a right of drainage in gross in favour of the Southern Midlands Council over the area marked "DRAINAGE EASEMENT 'B' 3.00 WIDE" shown on the Plan.

Lot 99 on the Plan is subject to a right of drainage in gross in favour of the Southern Midlands Council over the area marked "DRAINAGE EASEMENT 'H' 2.50 WIDE" shown on the Plan.

Lot 99 on the Plan is subject to a Pipeline and Services Easements in gross in favour of Taswater over the area marked "PIPELINE & SERVICES EASEMENT 'C' 2.50 WIDE" shown on the Plan.

Lot 99 on the Plan is subject to a Pipeline and Services Easements in gross in favour of TasWater over the area marked "PIPELINE & SERVICES EASEMENT 'A' 3.00 WIDE" shown on the Plan.

Lot 99 on the Plan is subject to a right of drainage in gross in favour of the Southern Midlands Council over the area marked "DRAINAGE EASEMENT 'A' 3.00 WIDE" shown on the Plan.

Lot 99 on the Plan is subject to a right of drainage in gross in favour of the Southern Midlands Council over the area marked "DRAINAGE EASEMENT 'E' 3.00 WIDE & VARIABLE WIDTH" shown on the Plan.

Lot 99 on the Plan is subject to Pipeline and Services Easements in gross in favour of TasWater over the area marked "PIPELINE & SERVICES EASEMENT 'E' 3.00 WIDE, shown on the Plan. ANILVAMUE

& VARIABLE WIDTH"

Lot 99 on the Plan is subject to a right of drainage in gross in favour of the Southern Midlands Council over the area marked "DRAINAGE EASEMENT 'G' 6.00 WIDE" shown on the Plan.

Lot 100 on the Plan is subject to a right of drainage in gross in favour of the Southern Midlands Council over the area marked "DRAINAGE EASEMENT 'E' 3.00 WIDE & VARIABLE WIDTH" shown on the Plan.

NOTE: Every annexed sheet must be signed by the parties to the dealing or where the party is a corporate body be signed by the persons who have attested the affixing of the seal of that body to the dealing.

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& VARIABLE WIDTH"

Lot 100 on the Plan is subject to Pipeline and Services Easements in gross in favour of TasWater over the area marked "PIPELINE & SERVICES EASEMENT 'E' 3.00 WIDE' shown on the Plan.

(appurtenant to Lots 2 to 9 on Sealed Plan 35320) &

Lot 101 on the Plan is subject to a right of drainage in gross in favour of the Southern Midlands Council over the area marked "DRAINAGE EASEMENT 3.00 WIDE (SP 35320)" shown on the Plan.

Lot 102 on the Plan is subject to a right of drainage in gross in favour of the Southern Midlands Council over the area marked "DRAINAGE EASEMENT 'E' 3.00 WIDE & VARIABLE WIDTH" shown on the Plan.

Lot 102 is subject to a right of Pipeline and Services Easement in favour of TasWater over the area marked "PIPELINE & SERVICES EASEMENT 'E', 3.00 WIDE" shown on the Plan.

'D' 2.50 *

Restrictive Covenants

The owner of each lot on the Plan covenants with the Vendor DFY INVESTMENT PTY LTD and the owners for the time being of every other lot shown on the plan to the extent that the burden of these covenants may run with and bind the Covenantor's lot and every part thereof and the benefit thereof shall be annexed to and devolve with each and every part of every other lot shown on the said Plan to observe the following stipulations:

- 1. Not to erect any building on any such lot with outer walls of asbestos cement sheeting.
- Not without prior written consent from the Vendor construct any walls of any building on any such
 lot from any material except, brick, stone, masonry block, or similar material, rendered insulated
 concrete forms, timber construction, flat metal cladding or insulated boards that are rendered,
 painted or pre-coloured.
- 3. Not to erect a dwelling on any such lot without a minimum of one (1) single garage under the roof of the dwelling.
- 4. Not to erect any dwelling house or residential building on a such lot using any roofing material or with roofs other than tiles or colourbond iron.
- 5. Not to erect any garage or outbuilding on any such lot using any roofing material or with roofs other than tiles or colourbond iron.
- 6. Not without prior written consent from the Vendor construct or allow to be constructed any kit home or relocatable dwelling on any such lot.

NOTE: Every annexed sheet must be signed by the parties to the dealing or where the party is a corporate body be signed by the persons who have attested the affixing of the seal of that body to the dealing.

28/7123 (2) 2/25 (2) 26/10/10/16 5/10/10/16 16/10/16/16

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FOLIO REFERENCE: C/T 36069/1

- 7. Not to erect or place or suffer to be or remain on any such lot any temporary building structure or caravan, except a shed or workshop that is used for the purpose of and in connection with, and during the construction of a permanent building or buildings on any such lot and not otherwise.
- 8. Not to erect on any such lot any buildings other than one private dwelling house and the usual outbuildings appurtenant thereto.
- 9. The main building erected on any portion of any such lot shall not be used for any other purpose than a private residential house.
- 10. Not to erect or permit to be erected or remain on any such lot any hoarding or advertising sign (except any notice or advertisement in the usual format for the sale or letting of any such lot or any building erected thereon).
- 11. Not to erect on any such lot any residential buildings of a size less than 125m2 (including an attached garage).
- 12. Not to erect a fence on any such lot in any material other than timber paling or colourbond iron or metal in the colour 'Monument'.

Interpretation

"Pipeline and Services Easement" is defined as follows: -

FIRSTLY, THE FULL AND FREE RIGHT AND LIBERTY for TasWater and its employees, contractors, agents and all other persons duly authorised by it, at all times to:

- (1) enter and remain upon the Easement Land with or without machinery, vehicles, plant and equipment;
- (2) investigate, take soil, rock and other samples, survey, open and break up and excavate the Easement Land for any purpose or activity that TasWater is authorised to do or undertake;
- (3) install, retain, operate, modify, relocate, maintain, inspect, cleanse, repair, remove and replace the Infrastructure;
- (4) run and pass sewage, water and electricity through and along the Infrastructure;

(5) do all works reasonably required in connection with such activities or as may be authorised or required by any law:

NOTE: Every annexed sheet must be signed by the parties to the dealing or where the party is a corporate body be signed by the persons who have attested the affixing of the seal of that body to the dealing.

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- (a) without doing unnecessary damage to the Easement Land; and
- (b) leaving the Easement Land in a clean and tidy condition;
- (6) if the Easement Land is not directly accessible from a highway, then for the purpose of undertaking any of the preceding activities TasWater may with or without employees, contractors, agents and any other persons authorised by it, and with or without machinery, vehicles, plant and equipment enter the Lot from the highway at any vehicle entry and cross the Lot to the Easement Land; and
- (7) use the Easement Land as a right of carriageway for the purpose of undertaking any of the preceding purposes on other land, TasWater reinstating any damage that it causes in doing so to any boundary fence of the Lot.

SECONDLY, the benefit of a covenant in gross for TasWater with the registered proprietor/s of the Easement Land and their successors and assigns not to erect any building, or place any structures, objects, vegetation, or remove any thing that supports, protects or covers any Infrastructure on or in the Easement Land, without the prior written consent of TasWater to the intent that the burden of the covenant may run with and bind the servient land and every part thereof and that the benefit thereof may be annexed to the easement herein described.

Interpretation:

"Infrastructure" means infrastructure owned or for which TasWater is responsible and includes but is not limited to:

- (a) sewer pipes and water pipes and associated valves;
- (b) telemetry and monitoring devices;
- (c) inspection and access pits;
- (d) electricity assets and other conducting media (excluding telemetry and monitoring devices);
- (e) markers or signs indicating the location of the Easement Land or any other Infrastructure or any warnings or restrictions with respect to the Easement Land or any other Infrastructure;
- (f) anything reasonably required to support, protect or cover any other Infrastructure;

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FOLIO REFERENCE: C/T 36069/1

- (g) any other infrastructure whether of a similar nature or not to the preceding which is reasonably required for the piping of sewage or water, or the running of electricity, through the Easement Land or monitoring or managing that activity; and
- (h) where the context permits, any part of the Infrastructure.

"TasWater" means Tasmanian Water & Sewerage Corporation Pty Ltd (ACN 162 220 653), its successors and assigns.

Fencing Covenant

In respect of each lot on the Plan the Vendor, DFY INVESTMENT PTY LTD shall not be required to fence.

EXECUTED by DFY INVESTMENT

PTY LTD (ACN 649 916 914) pursuant to)
section 127(1) of the Corporations Act)
2001 by being signed by:

Signature

Signature

Signature

ANGELLO FLARALLO

Print name in BLOCK LETTERS

Print position held in BLOCK LETTERS

Print position held in BLOCK LETTERS

NOTE: Every annexed sheet must be signed by the parties to the dealing or where the party is a corporate body be signed by the persons who have attested the affixing of the seal of that body to the dealing.

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